




SERIAL NUMBER: 20232612353 (NORTH LEBANON TWP)  
DATE: 09/18/23

# PRELIMINARY/FINAL LAND DEVELOPMENT PLAN FOR SUNNY LANE FOODS SCOUT COLD LOGISTICS, LLC

LOCATED IN  
NORTH LEBANON TOWNSHIP  
LEBANON COUNTY PENNSYLVANIA  
FEBRUARY 26, 2024

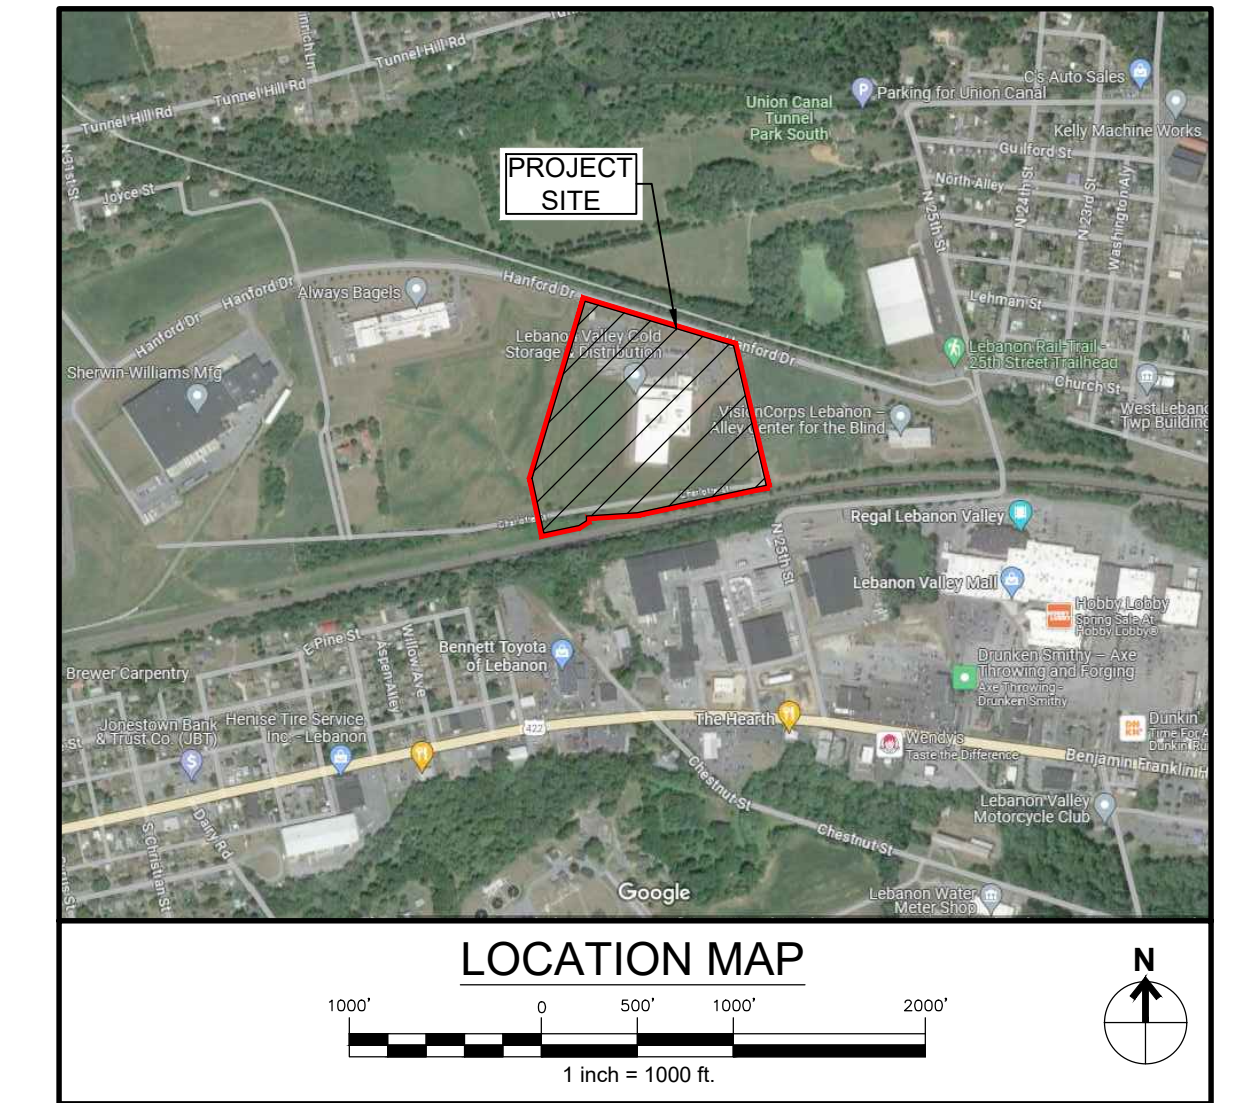

(1) PURSUANT TO SECTION 4, CLAUSE (2) OF SAID ACT, STECKBECK ENGINEERING & SURVEYING, INC. REQUESTED THE LINE AND FACILITY INFORMATION PRESCRIBED BY SECTION 2, CLAUSE (4) FROM A ONE CALL SYSTEM NOT LESS THAN TEN NOR MORE THAN NINETY WORKING DAYS BEFORE FINAL DESIGN IS TO BE COMPLETED.

(2) PURSUANT TO SECTION 4, CLAUSE (3) OF SAID ACT, STECKBECK ENGINEERING & SURVEYING, INC. SHOWN UPON THE DRAWING(S) THE POSITION AND TYPE OF EACH FACILITY OWNERS LINE, DERIVED PURSUANT TO THE REQUEST MADE AS REQUIRED BY SECTION 4, CLAUSE (2), AND THE NAME OF THE FACILITY OWNER, AND THE FACILITY OWNERS DESIGNATED OFFICE ADDRESS AND THE TELEPHONE NUMBER AS SHOWN ON THE LIST REFERRED TO IN SECTION 3.

(3) PURSUANT TO SECTION 4, CLAUSE (4) OF SAID ACT, STECKBECK ENGINEERING & SURVEYING, INC. MADE A REASONABLE EFFORT TO PREPARE THE CONSTRUCTION DRAWING(S) TO AVOID DAMAGE TO AND MINIMIZE INTERFERENCE WITH A FACILITY OWNERS FACILITIES IN THE CONSTRUCTION AREA BY MAINTAINING AN EIGHTEEN-INCH CLEARANCE OF THE FACILITY OWNERS FACILITIES WHERE POSSIBLE.

(4) PURSUANT TO SECTION 4, CLAUSE (5) OF SAID ACT, STECKBECK ENGINEERING & SURVEYING, INC. SHALL BE DEEMED TO HAVE MET THE OBLIGATIONS OF CLAUSE (2) BY CALLING A ONE CALL SYSTEM AND SHOWING AS PROOF THE SERIAL NUMBER OF THE ONE CALL NOTICE ON THE DRAWING(S). NORTH LEBANON TOWNSHIP, LEBANON COUNTY ID NO. 20232612353.

AND STECKBECK ENGINEERING & SURVEYING, INC. DOES NOT MAKE ANY REPRESENTATION, WARRANTY, ASSURANCE OR GUARANTEE THAT THE INFORMATION RECEIVED PURSUANT TO SAID REQUEST AND AS REFLECTED ON THESE DRAWINGS IS CORRECT OR ACCURATE, BUT STECKBECK ENGINEERING & SURVEYING, INC. IS REFLECTING SAID INFORMATION ON THESE DRAWINGS ONLY DUE TO THE REQUIREMENTS OF THE SAID ACT 187, DECEMBER 19, 1996.

WINDSTREAM  
1450 CENTER POINT ROAD  
HIAWATHA, IA 52233  
CONTACT: LOCATE DESK PERSONNEL  
EMAIL: LOCATE.DESK@WINDSTREAM.COM  
PHONE: 800-289-1901

VERIZON PENNSYLVANIA, LLC  
1026 HAY STREET  
PITTSBURGH, PA 15221  
CONTACT: DEBORAH BARUM  
PHONE: 412-344-3901

NORTH LEBANON TOWNSHIP  
725 KIMMERLINGS ROAD  
LEBANON, PA 17046  
CONTACT: OFFICE PERSONNEL  
EMAIL: PHONE: 171-273-7132

FIRSTENERGY CORPORATION  
21 S. MAIN STREET  
AKRON, OH 44308  
CONTACT: MELLYSSA ADAMS  
EMAIL: MADAMS@FIRSTENERGYCORP.COM  
PHONE: 610-807-3174


COMCAST CABLE LEBANON  
C/O USIC LOCATING SERVICES, INC.  
16085 HAMILTON CROSSING  
CARMEL, IN 46032  
CONTACT:USIC OFFICE PERSONNEL  
PHONE: 800-811-7981

CITY OF LEBANON AUTHORITY  
2311 RIDGEVIEW ROAD  
LEBANON, PA 17042  
CONTACT: BOB SENTZ  
EMAIL: BESENTZ@LEBANONAUTHORITY.ORG  
PHONE: 717-272-2841

LUMEN FORMERLY LEVEL 3  
1025 ELDORADO BLVD  
BROOMFIELD, CO 80021  
CONTACT: LUMEN OPERATOR PERSONNEL  
EMAIL: RELOCATIONS@LUMEN.COM  
PHONE: 877-366-8344 EXT. 3

UGI UTILITIES INC.  
1301 AIP DRIVE  
MIDDLETOWN, PA 17057  
CONTACT: STEPHEN BATEMAN  
EMAIL: SBATEMAN@UGI.COM  
PHONE: 610-807-3174

REVISION	DATE	BY

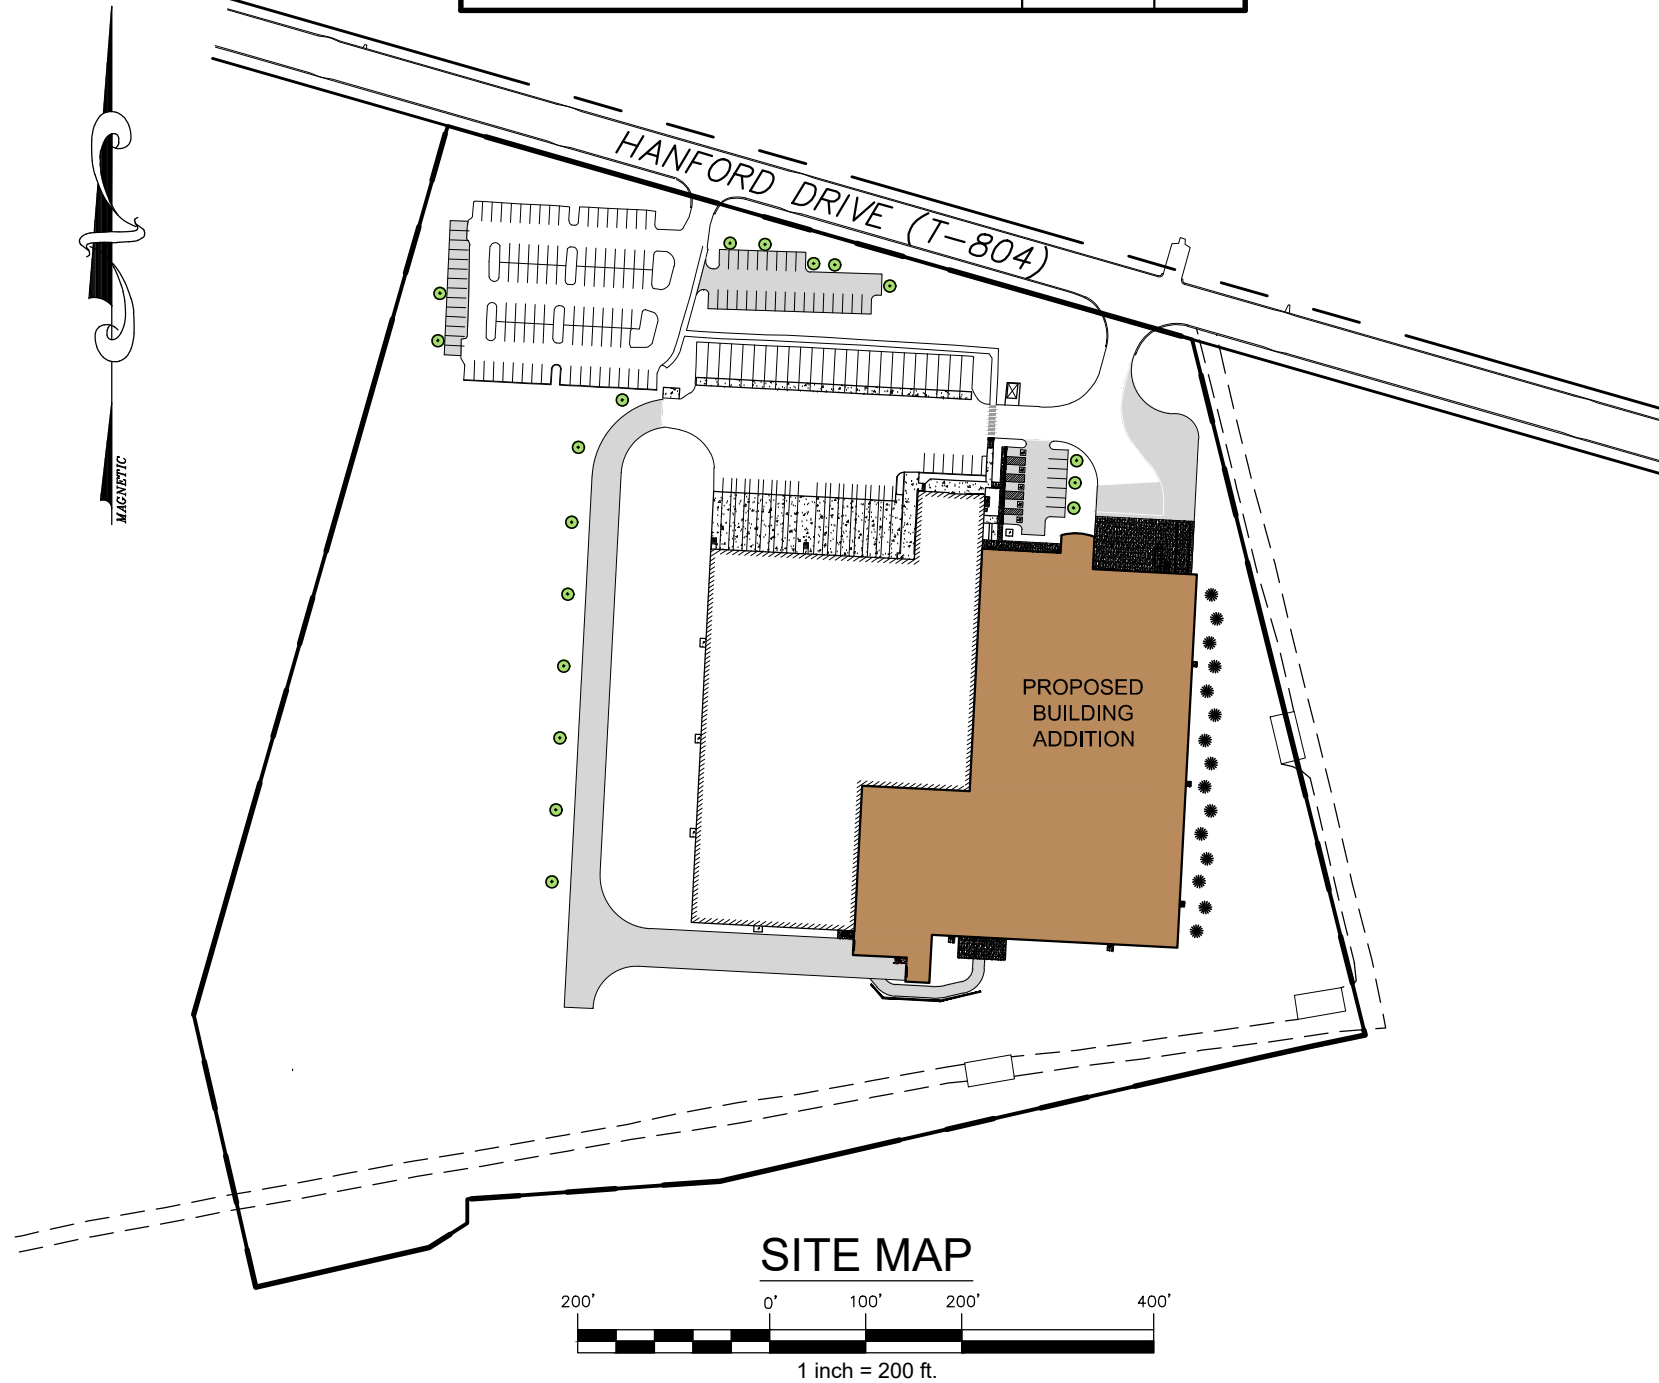

DRAWING LIST TABLE	
Sheet Number	Sheet Title
1	COVER SHEET
2	NOTES
3	EXISTING CONDITIONS
4	DEMOLITION PLAN
5	LAYOUT PLAN
6	EASEMENT PLAN
7	POST CONSTRUCTION STORMWATER MANAGEMENT PLAN
8	POST CONSTRUCTION STORMWATER MANAGEMENT NOTES
9	POST CONSTRUCTION STORMWATER MANAGEMENT DETAILS
10	POST CONSTRUCTION STORMWATER MANAGEMENT BASIN OUTLET DETAILS
11	GRADING PLAN
12	UTILITY PLAN
13	LANDSCAPING PLAN
14	LIGHTING PLAN
15	PROFILES
16	DETAILS
17	DETAILS
18	EROSION & SEDIMENTATION POLLUTION CONTROL PLAN
19	EROSION & SEDIMENTATION POLLUTION CONTROL NOTES
20	EROSION & SEDIMENTATION POLLUTION CONTROL DETAILS
21	EROSION & SEDIMENTATION POLLUTION CONTROL DETAILS

\* SHEETS 1-10 TO BE RECORDED

OWNER	OCCUPANT
SCOUT COLD STORAGE LEBANON HANFORD, LLC 4686 UNIVERSITY DRIVE COLLEGE DALE, TN. 37363 CONTACT: TOM DIPIRRO EMAIL: TOMDIPIRRO@SCOUTCOLD.COM PHONE: (201)-376-1769	SUNNY LANE FOODS & BAKERY, LLC 2750 HANFORD DRIVE LEBANON, PA. 17042 CONTACT: TODD LANGE PHONE: (717)-202-0415

SOURCE OF TITLE	SITE ADDRESS
DEED BOOK: 2335 PAGE: 5926 PIN: 27-2327941-371036-0000 SITE AREA: 22.83 AC.	2750 HANFORD DRIVE LEBANON, PA. 17042

### ZONING COMPLIANCE CHART

NORTH LEBANON TOWNSHIP ZONING DISTRICT: "I" INDUSTRIAL ZONING DISTRICT	
LOT AREA	REQUIRED 2 ACRES
LOT WIDTH	200'
LOT COVERAGE	50%
FRONT YARD SETBACK	100'
SIDE YARD SETBACK	20' (EACH SIDE)
REAR YARD SETBACK	30'
BUILDING HEIGHT	75'

SITE DATA	
SITE AREA	22.83 Acres
SITE ZONING	INDUSTRIAL (I)
EXISTING USE	MANUFACTURING
PROPOSED USE	MANUFACTURING
SOURCE OF WATER	PUBLIC
SOURCE OF SEWER	PUBLIC
SITE ADDRESS	2750 HANFORD DRIVE
STORMWATER MANAGEMENT DISTRICT	LEBANON COUNTY RESIDUAL

PARKING DATA	
-	1 SPACE FOR EVERY 1 EMPLOYEE ON THE LARGEST SHIFT.
-	1 SPACE PER 200 S.F. OF EXECUTIVE OFFICE FLOOR AREA.
-	EMPLOYEES: 115
-	OFFICE AREA: 6,000 S.F. = 25 SPACES
-	140 REQUIRED PARKING SPACES
-	162 PROPOSED PARKING SPACES PROVIDED

BMP/OUTFALL LOCATIONS		
BMP	LATITUDE	LONGITUDE
BASIN 1	40° 20' 34.49"	76° 27' 38.84"
BASIN 2	40° 20' 35.28"	76° 27' 27.74"

### NORTH LEBANON TOWNSHIP BOARD OF SUPERVISORS REVIEW CERTIFICATE

AT A MEETING HELD ON \_\_\_\_\_, 2024, THE BOARD OF SUPERVISORS OF NORTH LEBANON TOWNSHIP, LEBANON COUNTY, PENNSYLVANIA APPROVED THE LAND DEVELOPMENT PLAN OF THE PROPERTY AS SHOWN HEREON.

REVIEWED & APPROVED	DATE

### NORTH LEBANON TOWNSHIP PLANNING COMMISSION REVIEW CERTIFICATE

AT A MEETING HELD ON \_\_\_\_\_, 2024, THE NORTH LEBANON TOWNSHIP PLANNING COMMISSION REVIEWED THIS PLAN.

CHAIRMAN	SECRETARY	NOTARY PUBLIC

### OWNERS CERTIFICATION AND ACKNOWLEDGMENT

COMMONWEALTH OF PENNSYLVANIA )  
COUNTY OF \_\_\_\_\_ )

ON THIS, THE \_\_\_\_\_ DAY OF \_\_\_\_\_, 2024, BEFORE ME, A NOTARY PUBLIC, THE UNDERSIGNED OFFICER, PERSONALLY APPEARED \_\_\_\_\_ KNOWN TO ME (OR SATISFACTORILY PROVEN) TO BE THE PERSON(S) WHO BEING DULY SWORN ACCORDING TO LAW, DEPOSE AND SAY THAT HE/THEY ARE THE OWNERS OF THE PROPERTY SHOWN ON THIS PLAN, THAT THE PLAN THEREOF WAS MADE AT HIS/THEIR DIRECTION, THAT HE/THEY ACKNOWLEDGE THE SAME TO BE HIS/THEIR ACT AND PLAN AND DESIRES THE SAME TO BE RECORDED, AND THAT ALL STREETS AND OTHER PROPERTY IDENTIFIED AS PROPOSED PUBLIC PROPERTY (EXCEPTING THOSE AREAS LABELED "NOT FOR DEDICATION") ARE HEREBY DEDICATED TO PUBLIC USE, AND THAT ALL STORM WATER MANAGEMENT FACILITIES ARE TO BE PERMANENT FIXTURES THAT CAN BE ALTERED OR REMOVED ONLY AFTER APPROVAL OF A REVISED PLAN BY NORTH LEBANON TOWNSHIP.

SCOUT COLD STORAGE LEBANON HANFORD, LLC DATE \_\_\_\_\_

### ENGINEER'S CERTIFICATION

I HEREBY CERTIFY, TO THE BEST OF MY KNOWLEDGE, THE STORM WATER MANAGEMENT FACILITIES SHOWN AND DESCRIBED HEREON ARE DESIGNED IN CONFORMANCE WITH THE NORTH LEBANON TOWNSHIP SUBDIVISION AND LAND DEVELOPMENT ORDINANCE.

STEPHEN A. SHERK, P.E. DATE \_\_\_\_\_

### LEBANON COUNTY PLANNING DEPARTMENT

THIS PLAN REVIEWED BY THE LEBANON COUNTY PLANNING DEPARTMENT THIS \_\_\_\_\_ DAY OF \_\_\_\_\_

EXECUTIVE DIRECTOR \_\_\_\_\_  
NORTH LEBANON TOWNSHIP ENGINEER \_\_\_\_\_

### SURVEYOR'S CERTIFICATION


I HEREBY CERTIFY, TO THE BEST OF MY KNOWLEDGE, THAT THE SURVEY AND PLAN SHOWN AND DESCRIBED HEREON IS TRUE AND CORRECT TO THE ACCURACY REQUIRED BY THE NORTH LEBANON TOWNSHIP SUBDIVISION AND LAND DEVELOPMENT ORDINANCE.

JASON E. CHERNICH, P.L.S. DATE \_\_\_\_\_

### RECORDER OF DEEDS

RECORDED THIS \_\_\_\_\_ DAY OF \_\_\_\_\_, 20\_\_\_\_  
IN THE OFFICE FOR RECORDING OF DEEDS, ETC. IN AND FOR THE COUNTY OF LEBANON, PENNSYLVANIA, IN PLAN BOOK \_\_\_\_\_ PAGE \_\_\_\_\_



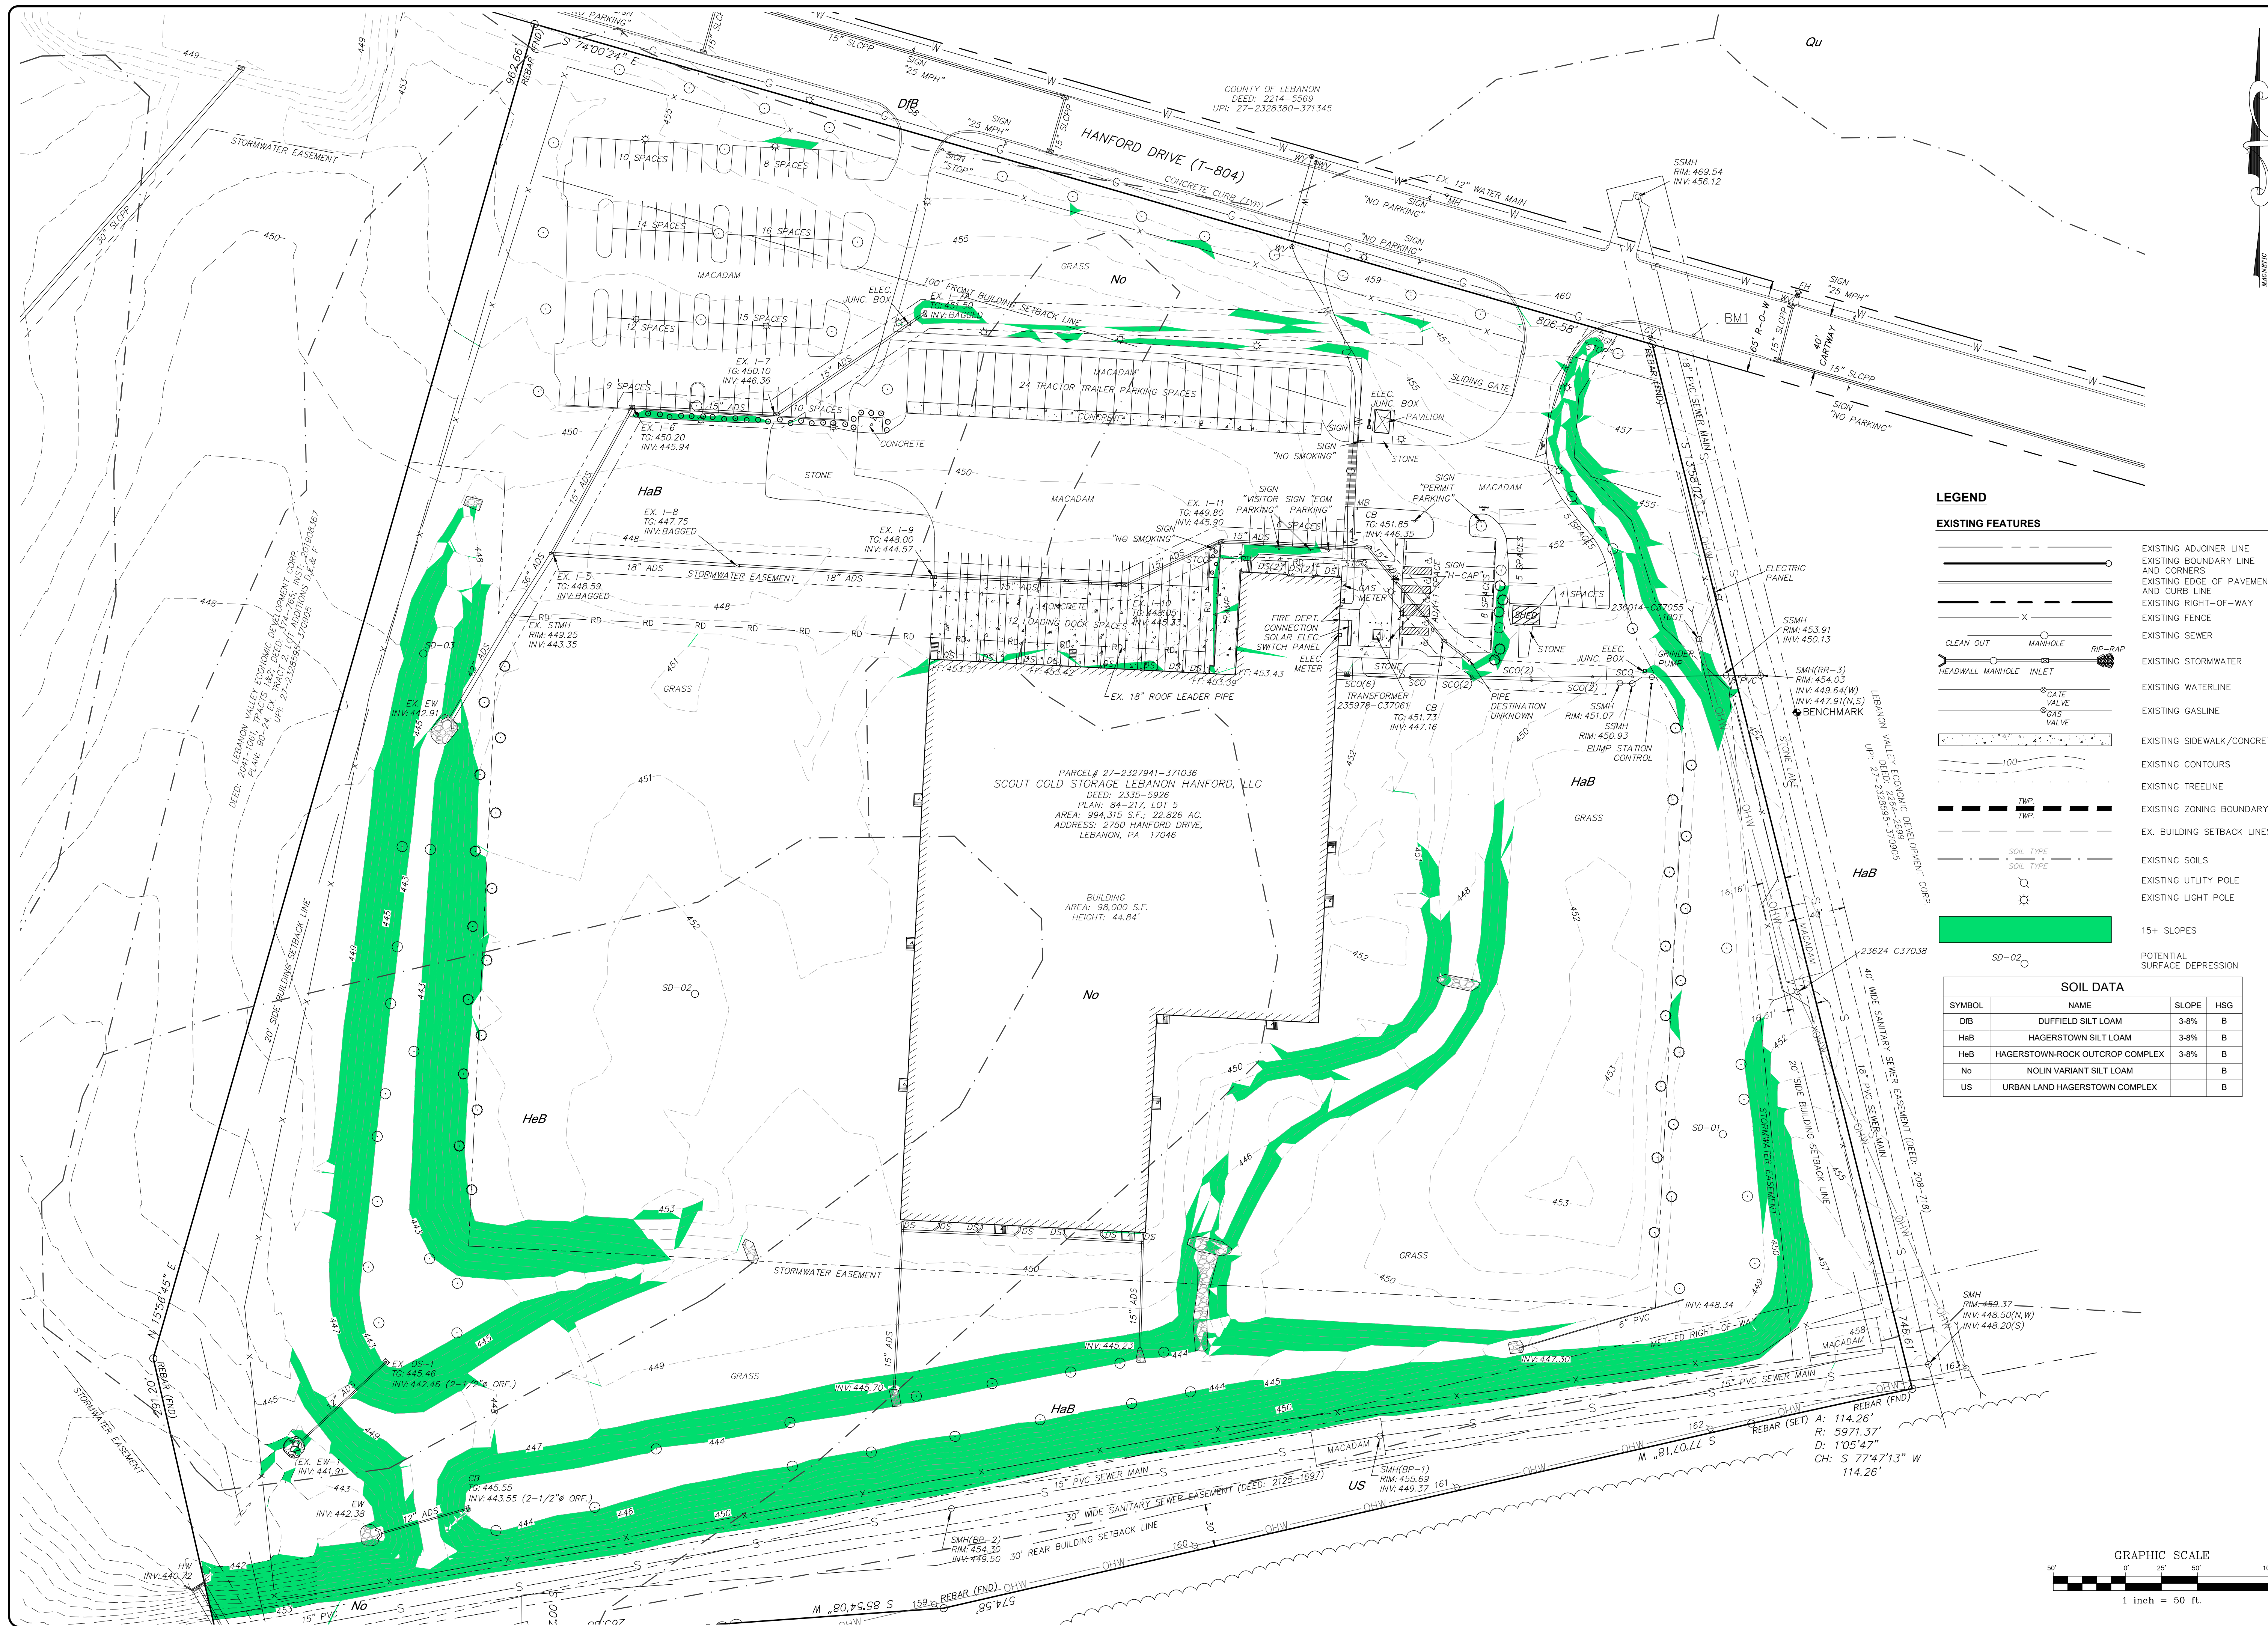


**LEGEND**

**EXISTING FEATURES**

- EXISTING ADJOINER LINE
- EXISTING BOUNDARY LINE AND CORNERS
- EXISTING EDGE OF PAVEMENT AND CURB LINE
- EXISTING RIGHT-OF-WAY
- EXISTING FENCE
- EXISTING SEWER
- EXISTING STORMWATER
- EXISTING WATERLINE
- EXISTING GASLINE
- EXISTING SIDEWALK/CONCRETE
- EXISTING CONTOURS
- EXISTING TRENLINE
- EXISTING ZONING BOUNDARY
- EX. BUILDING SETBACK LINES
- EXISTING SOILS
- EXISTING UTILITY POLE
- EXISTING LIGHT POLE
- 15+ SLOPES
- POTENTIAL SURFACE DEPRESSION

**SOIL DATA**

SYMBOL	NAME	SLOPE	HSG
DB	DUFFIELD SILT LOAM	3-8%	B
HaB	HAGERSTOWN SILT LOAM	3-8%	B
HeB	HAGERSTOWN-ROCK OUTCROP COMPLEX	3-8%	B
No	NOLIN VARIANT SILT LOAM		B
US	URBAN LAND HAGERSTOWN COMPLEX		B

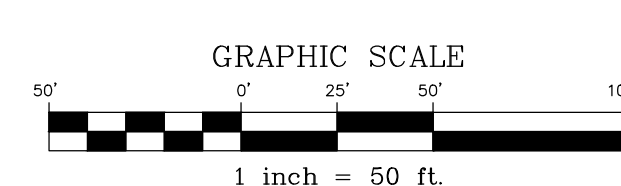

REVISION	DATE	BY

**EXISTING CONDITIONS**

**PRELIMINARY/FINAL LAND DEVELOPMENT PLANS**

For  
**SCOUT COLD LOGISTICS, LLC**

located in  
NORTH LEBANON TOWNSHIP  
LEBANON County, Pennsylvania

**HESI**  
Hagerstown Engineering & Surveying, Inc.  
279 Lebanon, Pennsylvania 17042  
Phone: (717) 272-7110  
Fax: (717) 272-7348

FIELD CREW: MOD,JEC  
BASE MAP: JEC  
DRAWN: CDS  
DESIGN: CDS  
CHECKED: SAS  
DATE: 02/26/24  
SCALE: 1" = 50'  
PROJECT #2368-23-001



**LEGEND**

**EXISTING FEATURES**

	EXISTING ADJOINER LINE
	EXISTING BOUNDARY LINE AND CORNERS
	EXISTING EDGE OF PAVEMENT AND CURB LINE
	EXISTING RIGHT-OF-WAY
	EXISTING FENCE
	EXISTING SEWER
	EXISTING STORMWATER
	EXISTING WATERLINE
	EXISTING GASLINE
	EXISTING SIDEWALK/CONCRETE
	EXISTING CONTOURS
	EXISTING TREELINE
	EXISTING TOWNSHIP BOUNDARY
	EXISTING LIGHT POLE
	DEMO (TO BE REMOVED OR RELOCATED)

BY	
DATE	


REVISION	

**DEMOLITION PLAN**

PRELIMINARY/FINAL LAND DEVELOPMENT PLANS  
For  
**SCOUT COLD LOGISTICS, LLC**  
located in  
NORTH LEBANON TOWNSHIP  
LEBANON County, Pennsylvania

Crescent Surveying & Surveying, Inc.  
279 Lebanon, Pennsylvania 17042  
Phone: (717) 272-7110  
Fax: (717) 272-7348



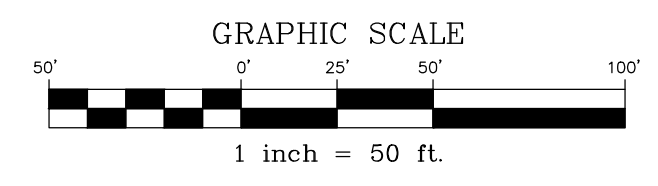


FIELD CREW:	MOD, JEC
BASE MAP:	JEC
DRAWN:	CDS
DESIGN:	CDS
CHECKED:	SAS
DATE:	02/26/24
SCALE:	1" = 50'
PROJECT #	2368-23-001





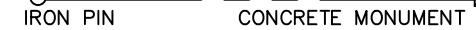



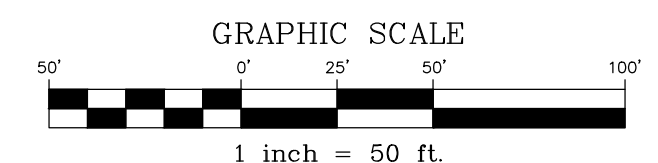
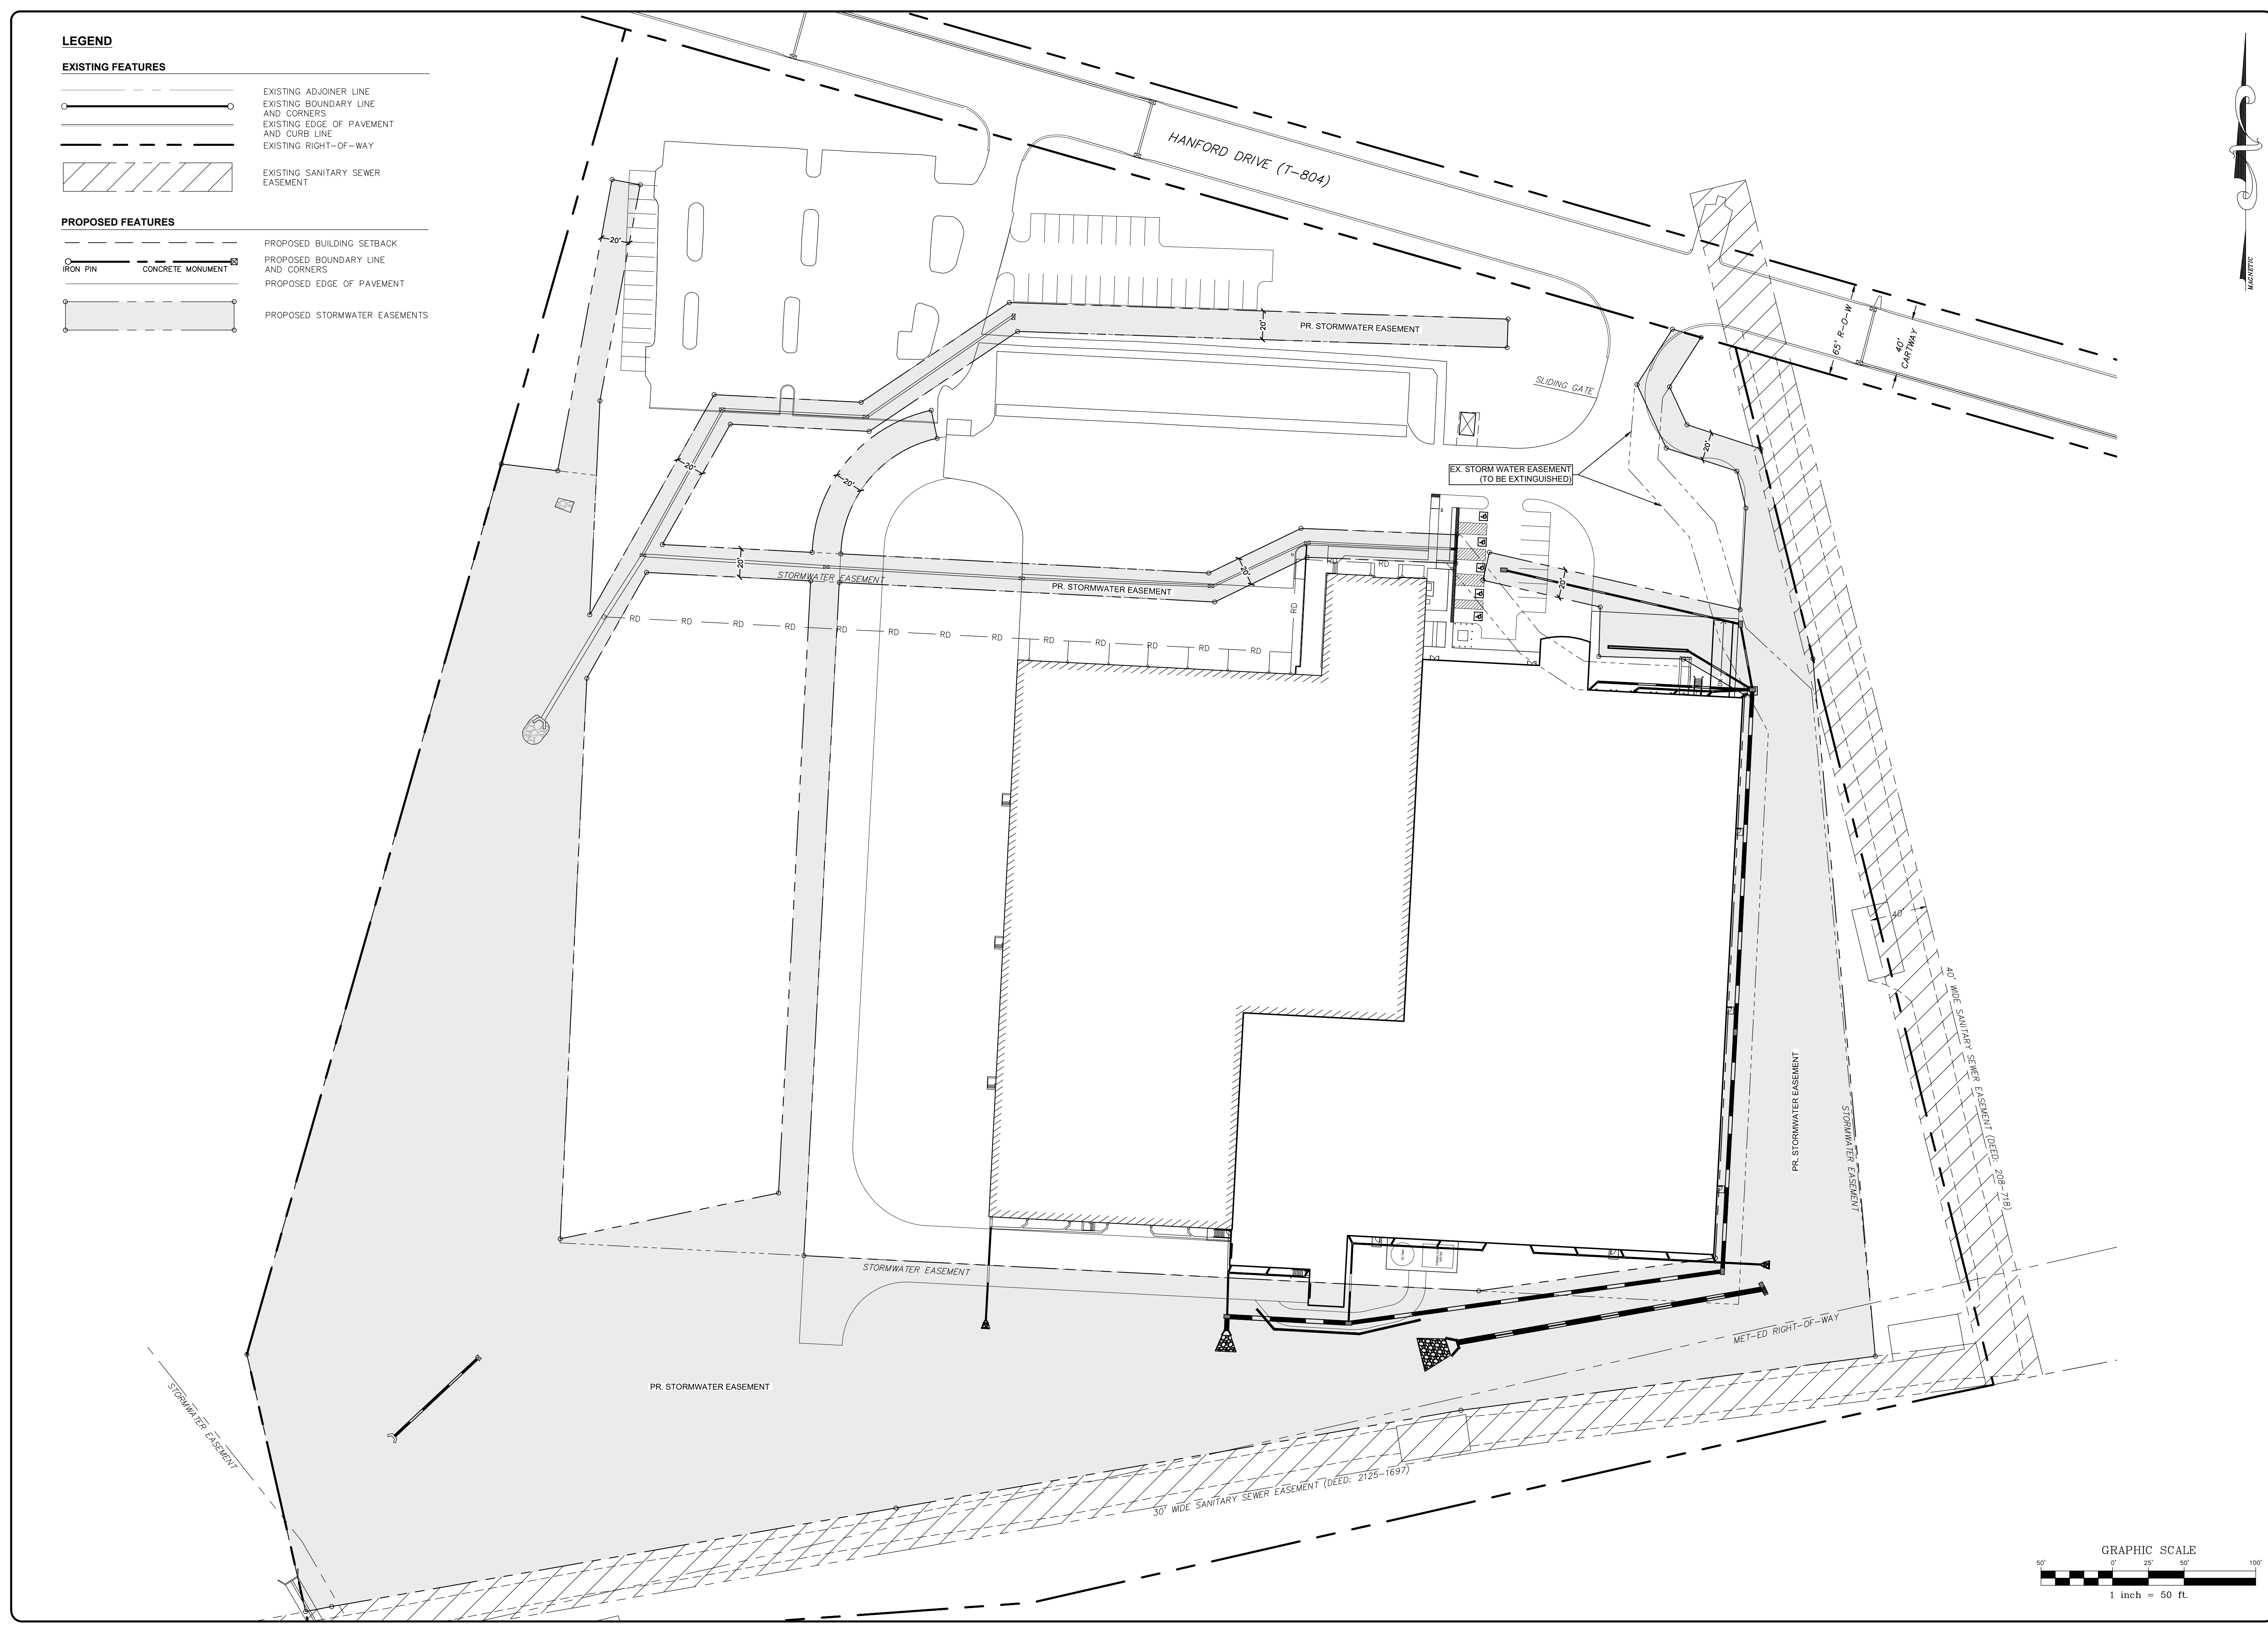
**LEGEND**

**EXISTING FEATURES**

-  EXISTING ADJONER LINE
-  EXISTING BOUNDARY LINE AND CORNERS
-  EXISTING EDGE OF PAVEMENT AND CURB LINE
-  EXISTING RIGHT-OF-WAY
-  EXISTING SANITARY SEWER EASEMENT

**PROPOSED FEATURES**

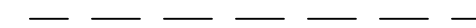-  PROPOSED BUILDING SETBACK
-  PROPOSED BOUNDARY LINE AND CORNERS
-  PROPOSED EDGE OF PAVEMENT
-  PROPOSED STORMWATER EASEMENTS



REVISION	DATE	BY


**EASEMENT PLAN**

PRELIMINARY/FINAL LAND DEVELOPMENT PLANS  
For  
**SCOUT COLD LOGISTICS, LLC**  
located in  
NORTH LEBANON TOWNSHIP  
LEBANON County, Pennsylvania


**RESI**  
Steebeck Engineering & Surveying, Inc.  
279 Lebanon, Pennsylvania 17042  
Phone: (717) 272-7110  
Fax: (717) 272-7348

FIELD CREW:	MOD, JEC
BASE MAP:	JEC
DRAWN:	CDS
DESIGN:	CDS
CHECKED:	SAS
DATE:	02/26/24
SCALE:	1" = 50'
PROJECT #	2368-23-001

**EXISTING FEATURES**

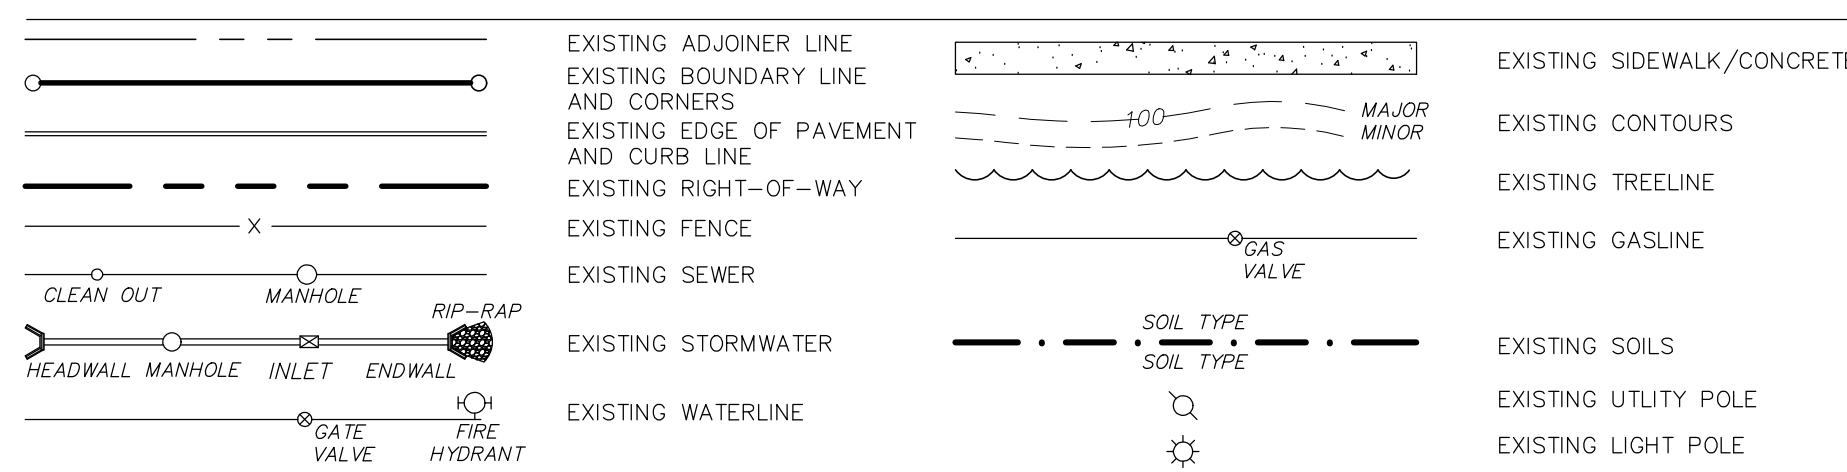

**PCSM FEATURES**

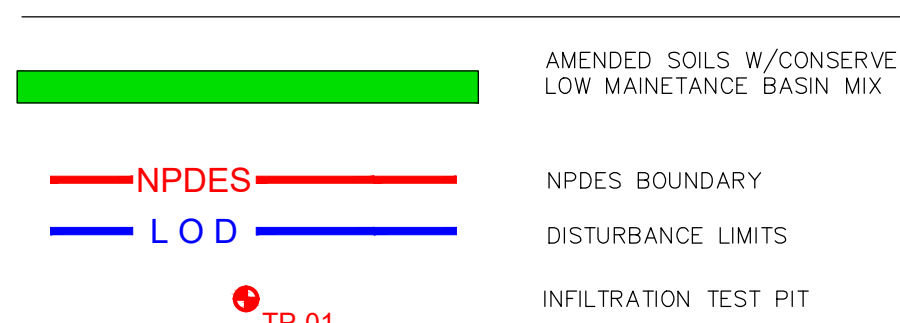



Map Symbol	Soil Name	Slope	Hydrologic Group
DfB	Duffield silt loam	3-8%	B
HaB	Hagerstown silt loam	3-8%	B
HeB	Hagerstown-Rock outcrop complex	3-8%	B
No	Nolin variant silt loam	-	B
US	Urban land-Hagerstown complex	-	B

**SCHEDULE OF MUNICIPAL INSPECTIONS**


- A. THE TOWNSHIP ENGINEER SHALL INSPECT ALL PHASES OF CONSTRUCTION OF THE STORMWATER MANAGEMENT IMPROVEMENTS. INSPECTIONS SHALL INCLUDE THE FOLLOWING:
- STORM SEWER PIPE TRENCHING AND INSTALLATION
  - SWALE EXCAVATION AND INSTALLATION
  - INFILTRATION BASINS 1-2 & DETENTION BASIN 1
    - ROUGH GRADING
    - EXCAVATION TO SUBGRADE
    - UNDERDRAIN SYSTEM INSTALLATION
    - AMENDED SOIL INSTALLATION
    - OUTLET STRUCTURE AND OUTLET PIPE INSTALLATION (INCLUDING ANTI-SEEP COLLARS AND CLAY CORE)
  - FINAL SITE STABILIZATION
- B. DURING ANY STAGE OF THE WORK, IF THE TOWNSHIP ENGINEER DETERMINES THAT THE SWM BMPs ARE NOT BEING INSTALLED IN ACCORDANCE WITH THE APPROVED SWM SITE PLAN, NORTH LEBANON TOWNSHIP SHALL PROVIDE WRITTEN NOTIFICATION TO THE LAND OWNER AND/OR DEVELOPER AND THE STIPULATING THE DEFICIENCIES AND REQUIRE THAT THE DEFICIENCIES BE CORRECTED WITHIN 30 DAYS (OR LONGER AS MAY BE REQUIRED). IF THE DEFICIENCIES ARE NOT CORRECTED WITHIN THE SPECIFIED PERIOD OF TIME, NORTH LEBANON TOWNSHIP MAY:
- REVOKE ANY EXISTING PERMITS UNTIL SUCH DEFICIENCIES ARE CORRECTED TO THE SATISFACTION OF THE TOWNSHIP ENGINEER.
  - UTILIZE FINANCIAL SECURITY POSTED BY THE OWNER AND/OR DEVELOPER AS PART OF THE DEVELOPER'S IMPROVEMENT GUARANTEE AGREEMENT TO INSTALL ANY UNFINISHED FACILITIES OR REMEDY ANY IMPROPERLY CONSTRUCTED FACILITIES.
  - PURSUDE OTHER LEGAL REMEDIES PURSUANT TO ARTICLE XI OF THIS ORDINANCE.
  - AFTER RECEIPT OF THE CERTIFICATE OF COMPLETION LETTER AND AS-BUILT PLAN BY NORTH LEBANON TOWNSHIP, A FINAL INSPECTION SHALL BE CONDUCTED BY THE TOWNSHIP ENGINEER OR DESIGNATED REPRESENTATIVE TO CERTIFY COMPLIANCE WITH THIS ORDINANCE.
- C. SWM BMPs SHOULD BE INSPECTED BY THE LANDOWNER, OR THE OWNER'S DESIGNEE (INCLUDING THE TOWNSHIP FOR DEDICATED AND OWNED FACILITIES), ACCORDING TO THE FOLLOWING LIST OF MINIMUM FREQUENCIES:
- ANNUALLY FOR THE FIRST FIVE (5) YEARS FOLLOWING CONSTRUCTION.
  - ONCE EVERY THREE (3) YEARS THEREAFTER.
  - DURING OR IMMEDIATELY FOLLOWING A 10-YEAR OR GREATER STORM. THE 10-YEAR STORM IS 4.6 INCHES OF RAINFALL IN A 24-HOUR PERIOD.

BMP CAPACITY		
BMP	INFILTRATION VOLUME (C.F.)	STORAGE VOLUME (C.F.)
INFILTRATION BASIN 1	59,922	325,525
INFILTRATION BASIN 2	12,190	46,329

**PROPOSED FEATURES**

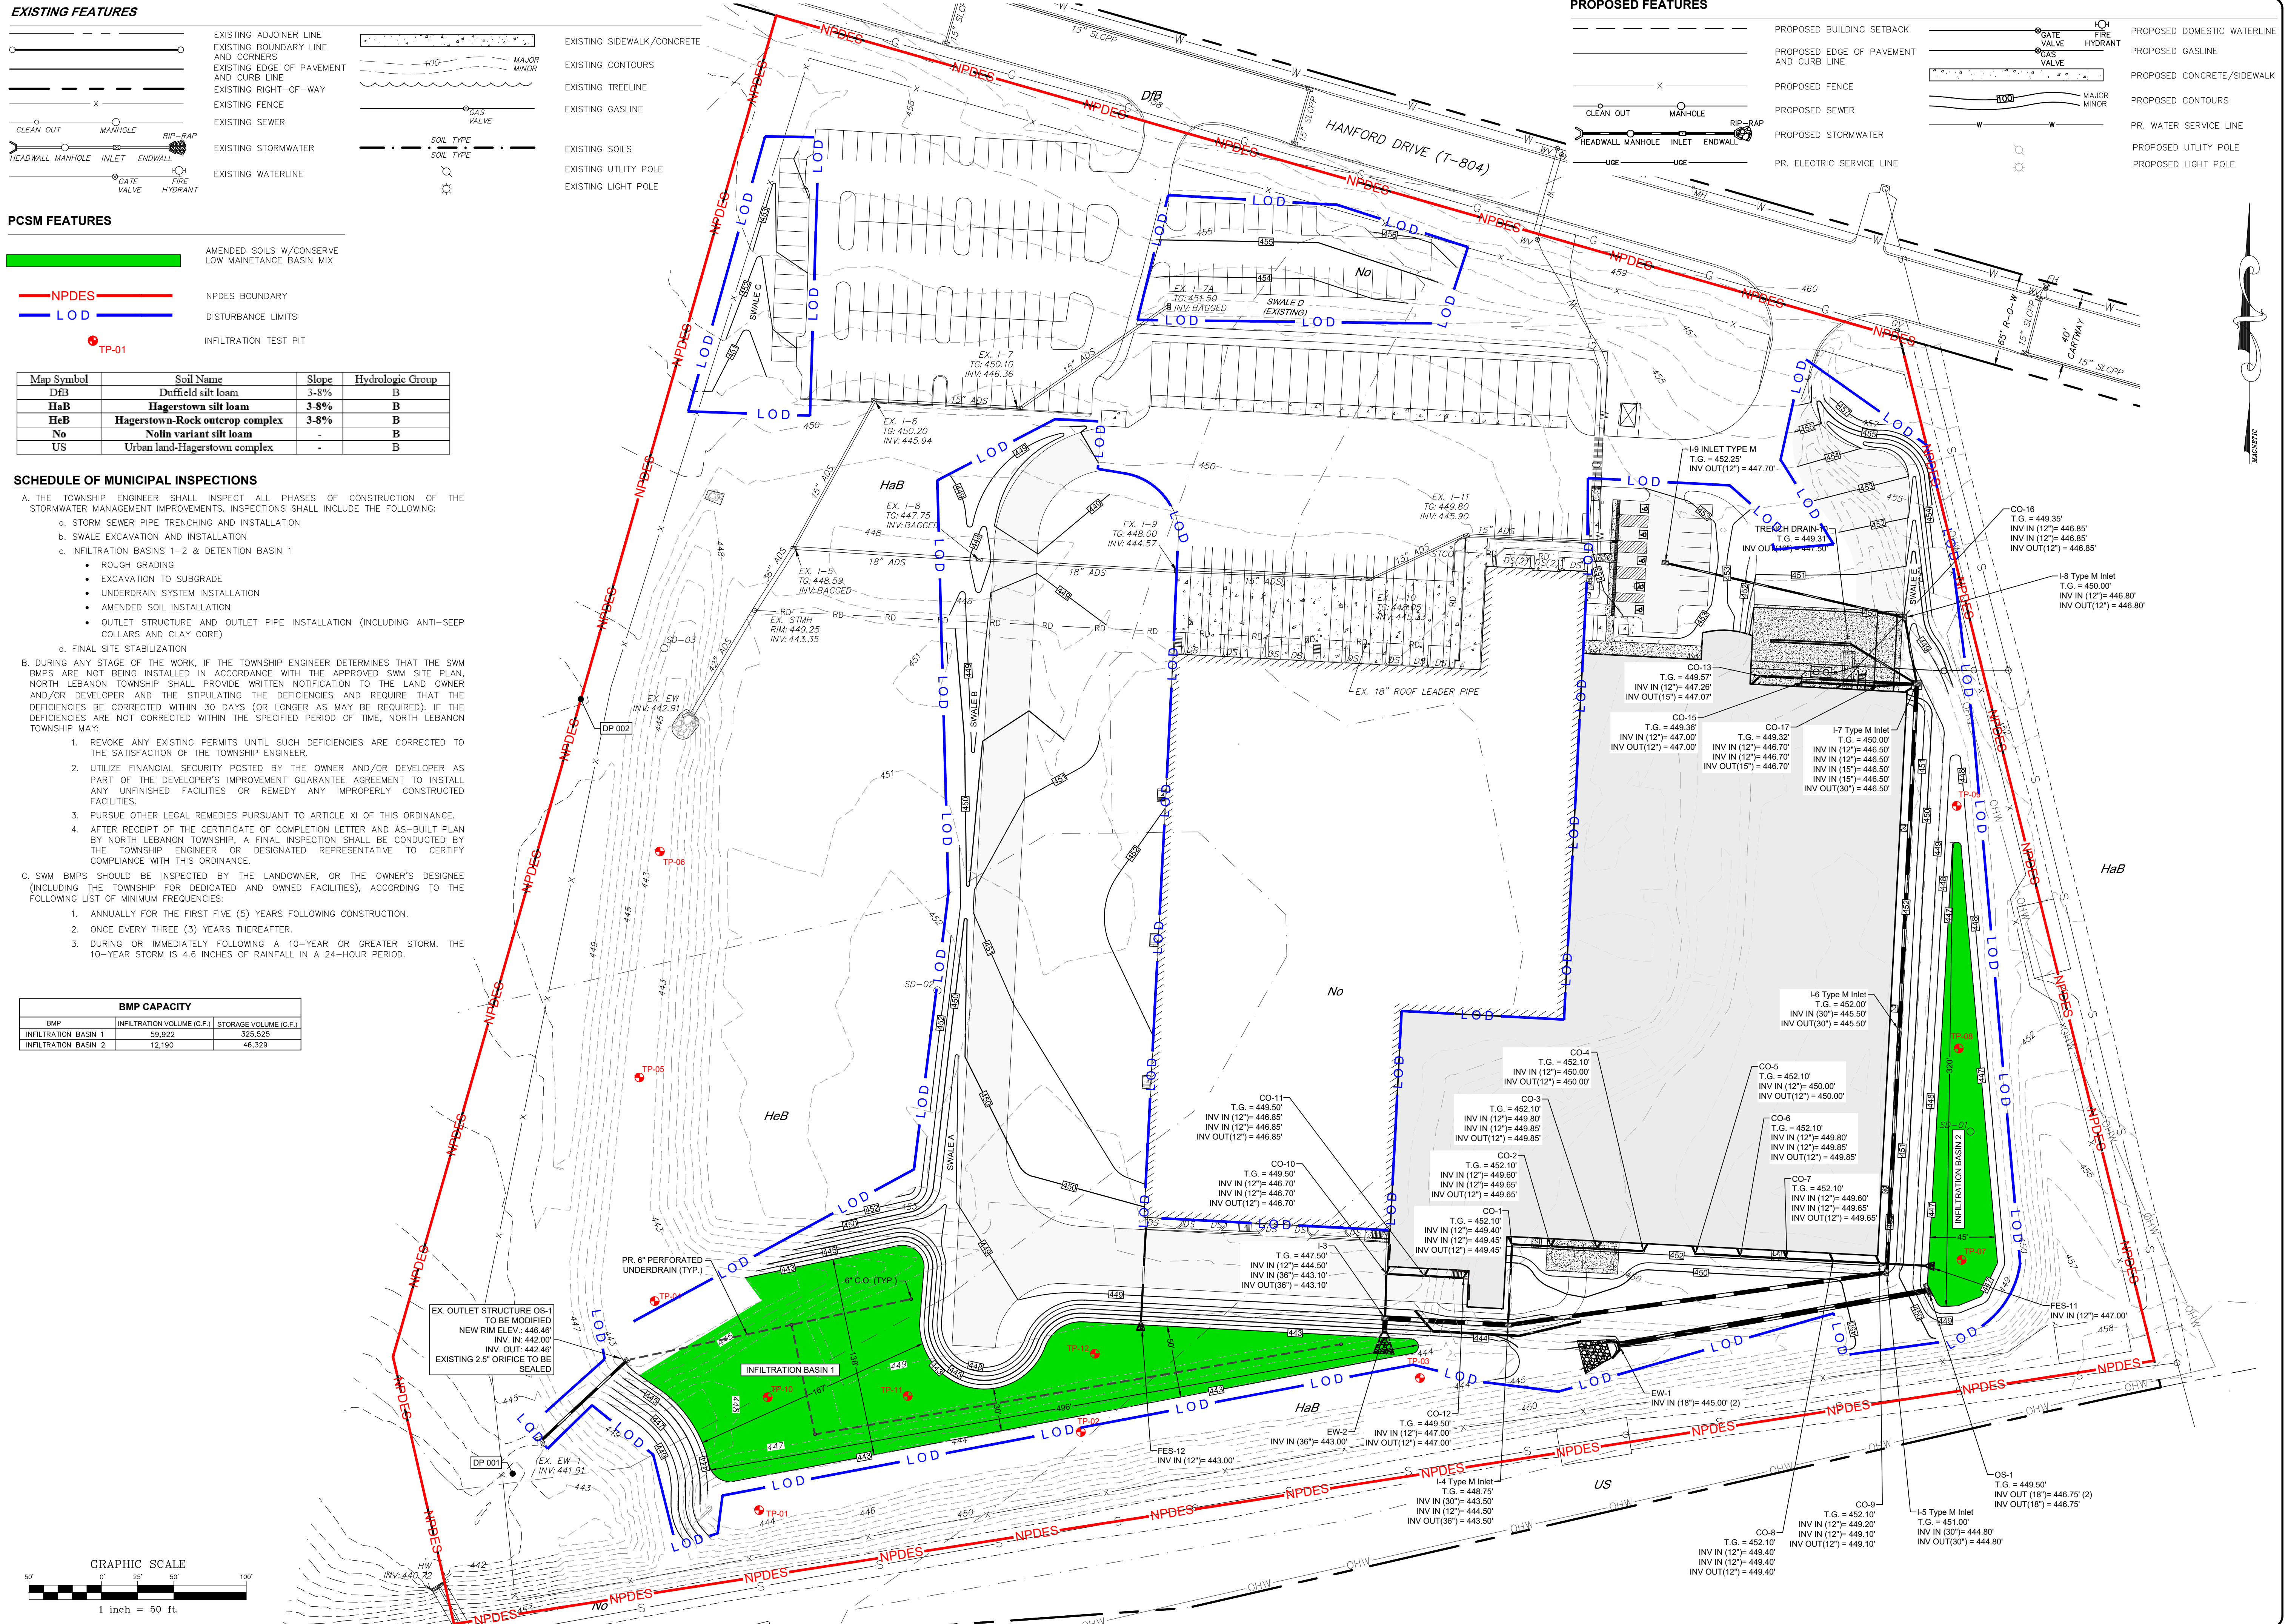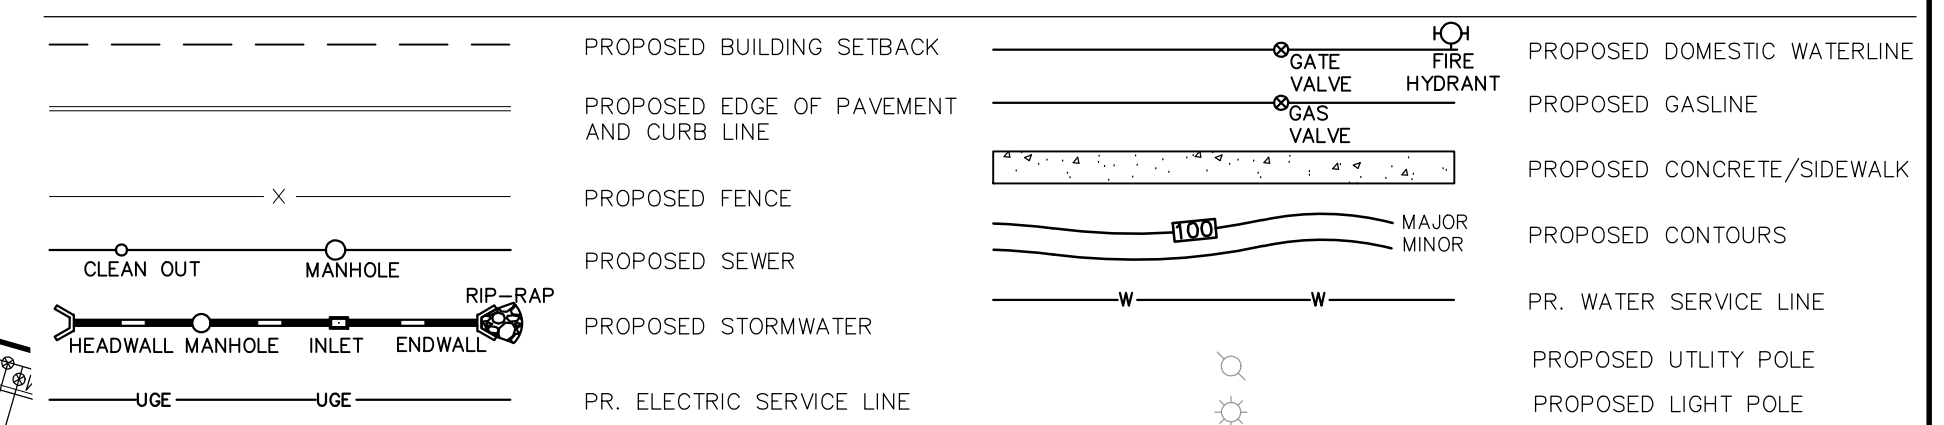

**GRAPHIC SCALE**

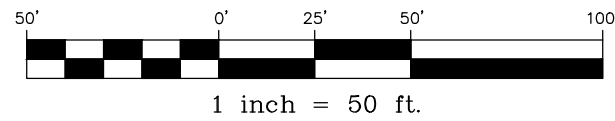

NO.	DATE	REVISION

**POST CONSTRUCTION STORMWATER MANAGEMENT PLAN**  
**PRELIMINARY/FINAL LAND DEVELOPMENT PLANS**  
 For  
**SCOUT COLD LOGISTICS, LLC**  
 located in  
 NORTH LEBANON TOWNSHIP  
 LEBANON County, Pennsylvania

Steadbeck Engineering & Surveying, Inc.  
 279 Lebanon, Pennsylvania 17042  
 Phone: (717) 272-7110  
 Fax: (717) 272-7348

FIELD CREW: MOD, JEC
BASE MAP: JEC
DRAWN: CDS
DESIGN: CDS
CHECKED: SAS
DATE: 02/26/24
SCALE: 1" = 50'
PROJECT # 2368-23-001

**POST CONSTRUCTION STORMWATER MANAGEMENT NARRATIVE**  
**SCOUT COLD LOGISTICS, LLC - SUNNY LANE FOODS BUILDING EXPANSION**

THIS NARRATIVE IS INTENDED TO ACCOMPANY THE POST CONSTRUCTION STORMWATER MANAGEMENT PLAN FOR THE PROPOSED PRELIMINARY/FINAL LAND DEVELOPMENT PLAN FOR SCOUT COLD LOGISTICS, LLC - SUNNY LANE FOODS BUILDING EXPANSION LOCATED AT 2750 HANFORD DRIVE IN NORTH LEBANON TOWNSHIP, LEBANON COUNTY. THIS NARRATIVE SHALL BE CONSIDERED A PART OF THE POST CONSTRUCTION STORMWATER MANAGEMENT PLAN.

**PROJECT DETAILS**

THE TOTAL TRACT OF PROPERTY IN QUESTION IS 22.83 ACRES. THE TOTAL SITE AND EARTH DISTURBANCE AS PART OF THIS PROJECT IS 8.90 ACRES. THE PROJECT SITE IS A DEVELOPED LOT WITHIN AN EXISTING BUSINESS PARK. THE PARCEL CONTAINS AN EXISTING 98 000 S.F. BUILDING WITH ASSOCIATED PARKING AREAS, LOADING DOCKS, AND EXISTING STORMWATER MANAGEMENT FACILITIES. BASINS, SWALES, AND GOOGLE EARTH HISTORICAL IMAGERY. THE SITE WAS DEVELOPED IN 2016. PRIOR TO DEVELOPMENT, THE SITE WAS AN AGRICULTURAL FIELD DATING BACK TO THE EARLY 1990'S. THE SITE IS BORDERED TO THE NORTH BY HANFORD DRIVE, TO THE EAST AND WEST BY AGRICULTURAL FIELDS, AND TO THE SOUTH BY THE NORFOLK SOUTHERN RAILROAD. PROPOSED IMPROVEMENTS INCLUDE THE CONSTRUCTION OF A 110.00 +/- S.F. BUILDING EXPANSION WITH ASSOCIATED LOADING DOCKS, PARKING AREAS, AND INTERNAL ACCESS DRIVE. THE BUILDING EXPANSION WILL BE SERVED BY PUBLIC WATER AND SEWER. PROPOSED IMPROVEMENTS ALSO INCLUDE MODIFICATIONS TO THE EXISTING STORMWATER MANAGEMENT BASINS TO BRING ALL SITE DEVELOPMENT (INCLUDING PREVIOUS SITE IMPROVEMENTS AND THE PROPOSED EXPANSION) UP TO CURRENT NPDES STANDARDS FOR PCSM DESIGN. THE THREE EXISTING BASINS WILL BE MODIFIED INTO TWO (2) ABOVE GROUND INFILTRATION BASINS TO MANAGE THE SITE RUNOFF. THE NEAREST MAPPED DOWNSTREAM SURFACE WATER IS THE QUITTAPAHILLA CREEK WHICH IS DESIGNATED AS A TROUT STOCKED FISHERY (TSF). THE QUITTAPAHILLA CREEK IS IMPAIRED ACCORDING TO CATEGORY 4C OF THE PA INTEGRATED WATER QUALITY MONITORING AND ASSESSMENT REPORT FOR AQUATIC LIFE. STREAMBANK MODIFICATIONS / DESTABILIZATION - HABITAT ALTERATIONS AND AQUATIC LIFE URBAN RUNOFF / STORM SEWERS - FLOW REGIME MODIFICATION. THE QUITTAPAHILLA CREEK IS ALSO IMPAIRED ACCORDING TO CATEGORY 5 OF THE PA INTEGRATED WATER QUALITY MONITORING AND ASSESSMENT REPORT FOR RECREATIONAL. SOURCE UNKNOWN - PATHOGENS.

**POST CONSTRUCTION**

POST CONSTRUCTION STORMWATER MANAGEMENT FACILITIES WERE DESIGNED IN ACCORDANCE WITH THE STANDARDS ESTABLISHED IN THE PENNSYLVANIA STORMWATER MANAGEMENT BMP MANUAL (PA DEP BUREAU OF WATERSHED MANAGEMENT, DECEMBER 2009), AND THE NORTH LEBANON TOWNSHIP STORMWATER MANAGEMENT ORDINANCE (ORDINANCE NO. 6-2022, 7/18/2022).

**HYDROLOGY**

A STORMWATER CONTROL SYSTEM IS PROPOSED TO MINIMIZE THE ADDITIONAL RUNOFF VOLUME GENERATED BY THE PROPOSED IMPROVEMENTS AND TO CONTROL THE FLOW TO A RATE LESSER THAN OR EQUAL TO THE PRE-DEVELOPMENT RUNOFF. FOLLOWING THE REQUIREMENTS OF THE PA CODE CHAPTER 102.8 AND THE NORTH LEBANON TOWNSHIP SWM ORDINANCE.

THE PROPOSED SITE IMPROVEMENTS WILL SHARE STORMWATER MANAGEMENT FACILITIES WITH THE EXISTING SITE IMPROVEMENTS. IN ORDER TO SHOW COMPLIANCE WITH CURRENT REGULATIONS, THE ENTIRE SITE IS BEING RE-ANALYZED FROM AN OVERALL VOLUME, RATE, AND WATER QUALITY PERSPECTIVE. TO ACHIEVE THIS, EXISTING CONDITIONS ARE ASSUMED AS MEADOW, PRIOR TO ANY DEVELOPMENT ON THE SITE. FOR CALCULATION PURPOSES, POST-CONSTRUCTION CONDITIONS ASSUME THAT ALL SITE DEVELOPMENT (ALL IMPROVEMENTS CONSTRUCTED AND 2016 AND PROPOSED NOW IN 2024) IS "PROPOSED" AND TREATED AS NEW IMPERVIOUS IN THE STORMWATER MANAGEMENT CALCULATIONS.

IN ORDER TO PROVIDE WATER QUALITY, VOLUME CONTROL, AND RATE CONTROL, THE SITE WILL BE SERVED BY TWO (2) INFILTRATION BASIN FACILITIES. THESE TWO (2) FACILITIES WILL BE LOCATED WITHIN THE SAME AREAS AS THE EXISTING STORMWATER MANAGEMENT BASINS LOCATED ON SITE. THE EXISTING BASINS WILL BE EXPANDED AND MODIFIED TO MEET CURRENT DESIGN STANDARDS.

THE BASINS ARE DESIGNED TO MANAGE THE POST-DEVELOPMENT DISCHARGE RATE TO A RATE EQUAL OR LOWER THAN THE PRE-DEVELOPMENT RATE AND TO MANAGE THE 2-YR 24-HOUR VOLUME INCREASE THROUGH INFILTRATION. THE CURVE NUMBERS ARE TAKEN FROM TR-55. SUPPORTING CALCULATIONS CAN BE SEEN IN THE DEP PCSM SPREADSHEETS.

PER THE NORTH LEBANON TOWNSHIP SWM MANAGEMENT ORDINANCE, POST-DEVELOPMENT DISCHARGE FLOW RATES MUST MEET THE FOLLOWING CRITERIA

Pre Developed	Post Developed
2 - year	< or = to 1-yr Pre
5 - year	< or = to 2-yr Pre
10 - year	< or = to 5-yr Pre
25 - year	< or = to 25-yr Pre
100 - year	< or = to 100-yr Pre

THE SCS METHOD WAS USED TO DETERMINE PEAK FLOW RATES FOR BOTH PRE- AND POST-DEVELOPED CONDITIONS. THE RESULTING POST DEVELOPMENT RUNOFF FLOW RATES WERE TABLED TO REQUIRED PRE-DEVELOPMENT RELEASE RATES AS REQUIRED IN THE TABLE ABOVE AND SEEN IN THE FLOW SUMMARY TABLE LATER IN THIS REPORT. HYDROCAD V10.0 SOFTWARE WAS USED TO PERFORM ALL BASIN ROUTING CALCULATIONS.

THIS PCSM PLAN IS DESIGNED TO MINIMIZE ANY INCREASE IN STORMWATER RUNOFF VOLUME AND ANY INCREASE IN THE RATE OF STORMWATER RUNOFF. IN ORDER TO ANALYZE THE EFFECTIVENESS OF THE PROPOSED STORMWATER MANAGEMENT PLAN THE DRAINAGE PATTERN IS ANALYZED AS TWO (2) POINTS OF INTEREST.

DP 001 - DISCHARGE POINT 001 IS TAKEN NEAR THE SOUTHWESTERN PROPERTY CORNER WHERE ALL EXISTING AND PROPOSED BASIN OUTLETS PIPES DISCHARGE. RUNOFF FROM DP 001 WILL FLOW THROUGH A SERIES OF EXISTING CULVERTS AND CHANNELS PRIOR TO REACHING THE QUITTAPAHILLA CREEK.

DP 002 - DISCHARGE POINT 002 IS TAKEN ALONG THE WESTERN PROPERTY LINE WHERE A SMALL PORTION OF PRE- AND POST-DEVELOPMENT RUNOFF WILL SHEET FLOW FROM DP 002 WILL FLOW ACROSS ADJACENT PROPERTY PRIOR TO REACHING THE SAME LOCATION AS DP 001 AND DOWNSTREAM SERIES OF EXISTING CULVERTS AND CHANNELS PRIOR TO REACHING THE QUITTAPAHILLA CREEK.

**THERMAL IMPACTS ANALYSIS**

EXISTING RUNOFF FROM THE SITE IS CURRENTLY TREATED BY THREE (3) EXISTING STORMWATER BASINS. THE EXISTING BASINS WILL BE MODIFIED INTO TWO (2) INFILTRATION BASINS TO TREAT THE MAJORITY OF THE DISTURBED SITE AND PROPOSED IMPERVIOUS AREAS. RUNOFF REACHING THE INFILTRATION BASINS WILL BE COOLED BY THE NATIVE VEGETATION IN THE BASIN BOTTOMS BEFORE BEING INFILTRATED THROUGH THE ENGINEERED SOIL MIX AND INTO THE GROUND. ADDITIONALLY, OVERFLOW FROM FROM INFILTRATION BASIN 2 WILL DISCHARGE INTO INFILTRATION BASIN 1 IN A TREATMENT TRIN WHICH WILL PROVIDE ADDITIONAL THERMAL RELIEF. SHADE TREES ARE ALSO PROPOSED IN AND AROUND THE NEW PARKING LOT EXPANSIONS TO SHADE THESE AREAS AND PROVIDE ADDITIONAL TEMPERATURE RELIEF FOR RUNOFF THAT FLOWS OVER THE IMPERVIOUS SURFACES.

**WATER QUALITY AND NON-DISCHARGE ANALYSIS**

THE SITE HAS BEEN DESIGNED TO MEET THE NPDES REQUIREMENTS AS CALCULATED IN THE DEP PCSM SPREADSHEET - QUALITY. THROUGH THE IMPLEMENTATION OF THE STRUCTURAL BMPs, THE WATER QUALITY REQUIREMENTS HAVE BEEN MET FOR THIS SITE. PLEASE SEE THE STANDARD DEP PCSM SPREADSHEETS FOR A MORE IN-DEPTH DESCRIPTION OF HOW THE REQUIREMENTS ARE MET FOR THIS SITE.

**PROPOSED BEST MANAGEMENT PRACTICES**

- INFILTRATION BASIN - TWO (2) INFILTRATION BASINS WILL BE UTILIZED TO PROMOTE INFILTRATION, EVAPORATION, AND EVAPOTRANSPIRATION AND CONTROL FLOW AND VOLUME LEAVING THE SITE.

**OFFSITE DISCHARGE ANALYSIS**

THE FOLLOWING IS AN EXCERPT FROM THE PA DEP FAQ SHEET LABELED **CHAPTER 102 OFF-SITE DISCHARGES OF STORMWATER TO NON-SURFACE WATERS** (JANUARY 2, 2019). FAQ #2 STATES, "PERSONS PROPOSED TO DISCHARGE MUST HAVE THE LEGAL AUTHORITY TO DISCHARGE. THEIR STORMWATER MUST BE RECEIVED BY THE INFILTRATION BASIN BOTTOMS BEFORE BEING INFILTRATED THROUGH THE ENGINEERED SOIL MIX AND INTO THE GROUND. ADDITIONALLY, OVERFLOW FROM FROM INFILTRATION BASIN 2 WILL DISCHARGE INTO INFILTRATION BASIN 1 IN A TREATMENT TRIN WHICH WILL PROVIDE ADDITIONAL THERMAL RELIEF. SHADE TREES ARE ALSO PROPOSED IN AND AROUND THE NEW PARKING LOT EXPANSIONS TO SHADE THESE AREAS AND PROVIDE ADDITIONAL TEMPERATURE RELIEF FOR RUNOFF THAT FLOWS OVER THE IMPERVIOUS SURFACES."

THE SITE DISCHARGES TO ALL DISCHARGE POINTS IN A SIMILAR MANNER AND AT A RATE THAT IS LESS THAN PRE-DEVELOPMENT FOR ALL STORM EVENTS.

**CHAPTER 102.8 (B) ANALYSIS**

THE DOWNSTREAM CHANNEL IS PROTECTED BY THE FLOW REDUCTION PROVIDED FROM THE PROPOSED STORMWATER MANAGEMENT FACILITIES. THE STRUCTURAL BMPs ALLOW FOR REDUCED FLOW TO THE DISCHARGE POINTS, AND THEREFORE THE DOWNSTREAM CHANNEL WILL NOT BE IMPACTED. THE SAME FLOW REDUCTION AND WATER QUALITY BENEFITS PROVIDED BY THE STRUCTURAL BMPs WILL ALSO SERVE TO PROTECT THE EXISTING DRAINAGE FEATURES AND DOWNSTREAM VEGETATION.

**SOIL INFORMATION AND GEOLOGY**

THE FOLLOWING SOLS ARE FOUND WITHIN OR ADJACENT TO THE AREA TO BE DISTURBED BY EARTH MOVING ACTIVITIES. THESE SOLS CAN ERODE WHEN DISTURBED. EROSION WILL BE CONTROLLED WITH STANDARD EROSION CONTROLS SUCH AS FILTER SOCK, SLOPE AND SWALE MATTING, RIPRAP OUTLET PROTECTION, INLET PROTECTION, ROCK FILTER, AND ROCK CONSTRUCTION ENTRANCE.

Map Symbol	Soil Name	Slope	Hydrologic Group
DfB	Duffield silt loam	3-8%	B
HaB	Hagerstown silt loam	3-8%	B
HeB	Hagerstown Rock outcrop complex	3-8%	B
Us	Nolin variant silt loam	-	B
No	Urban land-urban complex	-	B

"IF SOLS ARE BOLD, THEY ARE DISTURBED DURING CONSTRUCTION ON THIS PROJECT."

**KARST NOTES**

THE SITE IS UNDERLAIN BY THE ONTALANEE FORMATION WHICH IS COMPRISED OF DOLOMITE, LIMESTONE, AND CHERT. DOLOMITE AND LIMESTONE ARE SUSCEPTIBLE TO KARST ACTIVITY. THE PA DEP'S EMAPPA IDENTIFIES FIVE (5) SURFACE DEPRESSIONS ON THE PROJECT PROPERTY BUT NO SINKHOLES.

THE GEOTECHNICAL ENGINEERING REPORT FOR STORMWATER MANAGEMENT PREPARED BY ECS MID-ATLANTIC, LLC DID IDENTIFY THREE POTENTIAL (3) SURFACE DEPRESSIONS. THESE POTENTIAL SURFACE DEPRESSIONS WILL BE EXPLORED WITH A TEST PIT AT EACH LOCATION UNDER THE SUPERVISION OF ECS PRIOR TO CONSTRUCTION AT THE SITE IN ORDER TO DETERMINE IF POTENTIAL REPAIRS ARE NECESSARY. BASED ON THE AVAILABLE INFORMATION, THE RISK OF SINKHOLES AND RELATED KARST ACTIVITY ON THE SITE IS MODERATE. SHOULD A GEOTECHNICAL HAZARD BE ENCOUNTERED DURING CONSTRUCTION, THE LOCAL CONSERVATION DISTRICT WILL BE IMMEDIATELY CONTACTED AND A GEOTECHNICAL ENGINEER WILL BE REQUIRED TO OVERSEE ANY MITIGATION MEASURES.

IN ORDER TO REDUCE THE RATE OF SINKHOLE DEVELOPMENT AND IN KEEPING WITH THE GUIDELINES AND RECOMMENDATIONS OF THE PA BMP MANUAL, ECS RECOMMENDS THAT THE FOLLOWING DESIGN PRINCIPLES BE INCORPORATED:

- USE EXISTING DRAINAGE PATTERNS AND CHANNELS TO THE MAXIMUM EXTENT POSSIBLE.
  - TO THE PROPOSED INFILTRATION BASINS WILL BE LOCATED IN THE SAME LOCATION AS THE EXISTING STORMWATER MANAGEMENT BASINS.

- KEEP STORMWATER AWAY FROM KNOWN SINKHOLES OR PROBLEMATIC SUBSIDENCE AREAS:
  - THERE ARE NO KNOWN SINKHOLES ON SITE.
- AVOID CONCENTRATING STORMWATER:
  - RUNOFF WILL BE NATURALLY CONCENTRATED IN THE PROPOSED BASINS WHICH ARE DESIGNED IN ACCORDANCE WITH THE BELOW PRINCIPLES TO REDUCE THE RISK OF SINKHOLE FORMATIONS. ALL STORMWATER PIPE WILL UTILIZE WATER-TIGHT JOINTS.
- REDUCE RUNOFF VOLUME AND VELOCITY:
  - ON-SITE RUNOFF VOLUME WILL BE REDUCED IN ACCORDANCE WITH TOWNSHIP AND CHAPTER 102 REQUIREMENTS.
- USE BROAD SHALLOW BASINS:
  - INFILTRATION BASIN 1 HAS A MAXIMUM PONDING DEPTH OF LESS THAN 3'5" AND INFILTRATION BASIN 2 HAS A MAXIMUM PONDING DEPTH OF LESS THAN 3'.
- MAINTAIN THE FACILITIES POST CONSTRUCTION:
  - POST-CONSTRUCTION STORMWATER MANAGEMENT FACILITIES WILL BE MAINTAINED IN ACCORDANCE WITH THE OPERATION AND MAINTENANCE AGREEMENT REQUIRED BY THE TOWNSHIP AND RECORDED WITH THE PLAN.
  - UNDERDRAIN OR OTHER MEANS FOR DEWATERING IN STORMWATER MANAGEMENT FACILITIES IF NEEDED.
  - UNDERDRAINS ARE PROVIDED FOR EACH BASIN.

**DUFFIELD SOLS** - THE DUFFIELD SERIES CONSISTS OF DEEP AND VERY DEEP, WELL DRAINED SOLS FORMED IN RESIDUUM FROM LIMESTONE BEDROCK. SLOPES RANGE FROM 0 TO 35 PERCENT. PERMEABILITY IS MODERATE. MEAN ANNUAL PRECIPITATION IS 40 INCHES. MEAN ANNUAL TEMPERATURE IS 53 DEGREES F. DUFFIELD SOLS ARE SUSCEPTIBLE TO CUTBANKS AND CAVE INS AND MAY BE CORROSIVE TO STEEL AND CONCRETE. THIS SOIL MAY ALSO BE EASILY ERODIBLE AND SUBJECT TO HYDRIC INCLUSIONS. LOW STRENGTH, SLOW PERCOLATION, PIPING, AND A POOR SOURCE OF TOPSOIL. THIS SOIL IS ALSO SUSCEPTIBLE TO SHRINK/SWELL AND HAS THE POTENTIAL FOR SINKHOLE FORMATION. THIS SOIL IS ALSO SUBJECT TO WETNESS BUT NOT PONDING.

**HAGERSTOWN SOLS** - THE HAGERSTOWN SERIES CONSISTS OF DEEP AND VERY DEEP, WELL DRAINED SOLS FORMED IN RESIDUUM OF HARD GRAY LIMESTONE. SLOPE RANGES FROM 0 TO 45 PERCENT. PERMEABILITY IS MODERATE. MEAN ANNUAL PRECIPITATION IS 30 TO 45 INCHES. MEAN ANNUAL AIR TEMPERATURE IS 45 TO 56 DEGREES. HAGERSTOWN SOLS MAY BE SUSCEPTIBLE TO CUT BANKS AND CAVE INS AND CORROSIVE TO STEEL BUT NOT CONCRETE. THIS SOIL MAY ALSO BE EASILY ERODIBLE AND SUBJECT TO A SEASONALLY HIGH WATER TABLE, HYDRIC INCLUSIONS, LOW STRENGTH, SLOW PERCOLATION, PIPING, AND A POOR SOURCE OF TOPSOIL. HAGERSTOWN SOLS MAY ALSO BE SUSCEPTIBLE TO FROST ACTION, SHRINK/SWELL, AND SINKHOLES.

**NOLIN SOLS** - THE NOLIN SERIES CONSISTS OF VERY DEEP, WELL DRAINED SOLS FORMED IN ALLUVIUM DERIVED FROM LIMESTONES, SANDSTONES, SILTSTONES, SHALES, AND LOESS. THESE NEARLY LEVEL TO MODERATELY STEEP SOILS ARE ON FLOOD PLAINS, IN DEPRESSIONS WHICH RECEIVE RUNOFF FROM SURROUNDING SLOPES, OR ON NATURAL LEVEES OF MAJOR STREAMS AND RIVERS. SLOPE RANGES FROM 0 TO 25 PERCENT, BUT IS DOMINANTLY 0 TO 3 PERCENT. MEAN ANNUAL TEMPERATURE IS 56 DEGREES F. AND THE MEAN ANNUAL PRECIPITATION IS 43 INCHES. NOLIN SOLS MAY BE SUSCEPTIBLE TO CUT BANKS AND CAVE INS AND CORROSIVE TO CONCRETE BUT NOT STEEL. THIS SOIL MAY ALSO BE SUBJECT TO FLOODING, A SEASONALLY HIGH WATER TABLE, HYDRIC INCLUSIONS, LOW STRENGTH, SLOW PERCOLATION, AND PIPING. NOLIN SOLS MAY ALSO BE SUSCEPTIBLE TO SINKHOLE FORMATION.

**SOIL USE LIMITATIONS AND RESOLUTIONS**

- CUT-BANK CAVING: ALL APPLICABLE OSHA STANDARDS AND REGULATIONS SHALL BE IMPLEMENTED AT ALL TIMES DURING TRENCHING AND EXCAVATION OPERATIONS.
- CORROSION OF STEEL AND CONCRETE: ALL UNDERGROUND FOUNDATIONS AND STRUCTURES SHALL BE PROPERLY PROTECTED AGAINST CORROSION, WHICH MAY INCLUDE COATING THESE STRUCTURES WITH CORROSION-RESISTANT MATERIAL.
- EASILY ERODIBLE, EROSION AND SEDIMENT POLLUTION CONTROLS WILL BE IMPLEMENTED TO AVOID THE TRANSPORTATION OF CLAY, SILT, AND SAND TO ADJACENT WATERS.
- DEPTH TO SATURATED ZONE/SEASONAL HIGH WATER TABLE: THE SITE MAY REQUIRE DEWATERING OF PITS DURING CONSTRUCTION, I.E. WHEN POURING FOOTERS, EXCAVATING TRENCHES, DEWATERING BASINS, ETC. THE GEOTECHNICAL REPORT DID NOT IDENTIFY ANY AREAS OF HIGH GROUNDWATER. IF DEWATERING IS REQUIRED, A SUMP PIT AND FILTER BAG SHALL BE UTILIZED, AND WATER SHALL BE PUMPED TO AN UNDISTURBED AREA UPSTREAM OF A PERIMETER CONTROL BMP SUCH AS A FILTER SOCK.
- HYDRIC SOILS/HYDRIC INCLUSIONS: A WETLAND FIELD SURVEY WAS CONDUCTED AND NO WETLANDS ARE LOCATED ON SITE.
- LOW STRENGTH/LANDSLIDE PRONE: THE MAXIMUM PROPOSED SLOPE ON THE SITE IS 3:1. THIS WILL REDUCE THE POTENTIAL FOR EROSION AND LAND SLIDE ACTION. ALL PROPOSED BERMS SHALL BE COMPACTED FULLY IN ORDER TO PROTECT AGAINST CLAY COLLAPSE AND SOIL STABILIZATION IMMEDIATELY.
- SLOW PERCOLATION: ADEQUATE PRECAUTIONS WILL BE TAKEN TO ENSURE THAT THE PCSM BMPs INFILTRATE WITHIN THE REQUIRED TIME PERIOD, INCLUDING INFILTRATION TESTING AND SOIL MODIFICATION/UNDERDRAIN INSTALLATION, IF NECESSARY. INFILTRATION TESTS PREVIOUSLY PERFORMED INDICATED THAT THE INFILTRATION RATE AT THE SITE IS ADEQUATE IN THE PROPOSED INFILTRATION AREAS.
- PIPING: ANTI-SEEP COLLARS WILL BE PROVIDED AS PART OF THE PCSM AND PIPELINE DESIGNS.
- POOR SOURCE OF TOPSOIL: THE ADEQUACY OF THE TOPSOIL WILL BE EVALUATED UPON THE COMMENCEMENT OF EXCAVATION. AS THE MAJORITY OF THE PROJECT CONSISTS OF CONSTRUCTION OF IMPERVIOUS AREAS, THE TOPSOIL REQUIRED WILL BE MINIMAL.
- FROST ACTION: ALL IMPERVIOUS SURFACES SHALL BE GRADED AT A MINIMUM OF 1% IN ONE DIRECTION, SO THAT WATER WILL NOT COLLECT ON THE SURFACE AND CAUSE DAMAGE DURING FREEZE/THAW CYCLES. CRACKS WHICH DEVELOP IN THE IMPERVIOUS SURFACES SHALL BE PROMPTLY SEALED.
- SHRINK/SWELL: ALL SITE GRADING SHALL DIRECT WATER AWAY FROM BUILDINGS AND OTHER IMPERVIOUS SURFACES TO REDUCE THE LIKELIHOOD OF WATER INFILTRATING NEAR OR UNDER THESE STRUCTURES.
- SINKHOLE FORMATION: SEE KARST NOTES ABOVE.
- WETNESS: THE SITE MAY REQUIRE DEWATERING OF PITS DURING CONSTRUCTION, I.E. WHEN POURING FOOTERS, DEWATERING BASINS, ETC. SHOULD DEWATERING BE REQUIRED, A SUMP PIT AND FILTER BAG SHALL BE UTILIZED, AND WATER SHALL BE PUMPED TO AN UNDISTURBED AREA UPSTREAM OF A PERIMETER CONTROL (FILTER SOCK).
- FLOODING: THE SITE IS NOT LOCATED WITHIN A MAPPED FLOODPLAIN.

**GENERAL SOIL NOTES**

1. AREAS TO BE FILLED ARE TO BE CLEARED, GRUBBED, AND STRIPPED OF TOPSOIL TO REMOVE TREES, VEGETATION, ROOTS, AND OTHER OBJECTIONABLE MATERIAL. NEED TO HAVE APPROPRIATE EAS CONTROLS.
2. ALL FILLS SHALL BE COMPACTED AS REQUIRED TO REDUCE EROSION, SLURPAGE, SETTLEMENT, SUBSIDENCE OR OTHER RELATED PROBLEMS. FILL INTENDED TO SUPPORT BUILDINGS, STRUCTURES, AND CONDUIITS, ETC. SHALL BE COMPACTED IN ACCORDANCE WITH LOCAL REQUIREMENTS OR CODES.
3. ALL EARTHEN FILLS SHALL BE PLACED IN COMPACTED LAYERS NOT TO EXCEED 9 INCHES IN THICKNESS.
4. FILL MATERIALS SHALL BE FREE OF FROZEN PARTICLES, BRUSH, ROOTS, SOIL, OR OTHER FOREIGN OR OBJECTIONABLE MATERIALS THAT WOULD INTERFERE WITH OR PREVENT CONSTRUCTION OF SATISFACTORY FILLS.
5. FROZEN MATERIALS OR SOFT, MUKY, OR HIGHLY COMPRESSIBLE MATERIALS SHALL NOT BE INCORPORATED INTO FILLS.
6. FILLS SHALL NOT BE PLACED ON SATURATED OR FROZEN SURFACES.
7. THE LOCAL CONSERVATION DISTRICT SHALL BE CONTACTED IF SEEPS OR SPRINGS ARE ENCOUNTERED AND THE DESIGNS ARE ALTERED DURING CONSTRUCTION AND THEY SHALL BE HANDLED IN ACCORDANCE WITH THE STANDARD AND SPECIFICATION FOR SUBSURFACE DRAIN OR OTHER APPROVED METHOD.

**INFILTRATION TESTING REQUIREMENTS**

INFILTRATION TESTING HAS BEEN CONDUCTED AND RESULTS ARE PROVIDED IN THE GEOTECHNICAL ENGINEERING REPORT PREPARED BY ECS MID-ATLANTIC INCLUDED AS AN APPENDIX TO THIS PCSM REPORT.

**OWNERSHIP, OPERATIONS AND MAINTENANCE**

SHORT-TERM OWNERSHIP, OPERATIONS AND MAINTENANCE OF THE PCSM BMPs IS THE RESPONSIBILITY OF THE CONTRACTOR (UNKNOWN AT THIS TIME), WHO SHALL BE LISTED AS THE CO-PERMITTEE ON THE NPDES PERMIT. LONG-TERM OWNERSHIP, OPERATIONS AND MAINTENANCE OF THE PCSM BMPs IS THE RESPONSIBILITY OF THE PROPERTY OWNER (HEREIN IDENTIFIED AS SCOUT COLD LOGISTICS, LLC).

**INDIVIDUAL BMP DESCRIPTION, CONSTRUCTION SEQUENCE, AND MAINTENANCE**

GENERAL OVERALL BMP DESCRIPTION

**BMP 6.4.2: INFILTRATION BASIN**

AN INFILTRATION BASIN IS A SHALLOW IMPOUNDMENT THAT STORES AND INFILTRATES RUNOFF OVER A LEVEL, UN-COMPACTED (PREFERABLY UNDISTURBED AREA) WITH RELATIVELY PERMEABLE SOILS.

TWO (2) INFILTRATION BASINS WILL BE LOCATED ON SITE. THE BOTTOMS WILL BE CONSTRUCTED WITH AN ENGINEERED SOIL MIXTURE TO ASSIST IN THE WATER QUALITY BENEFITS OF FILTRATION AS WELL AS TO PROMOTE VEGETATION GROWTH AND INFILTRATION. THE INFILTRATION BASIN FACILITIES WILL BE PLANTED WITH ERNST CONSERVATION SEEDS "RETENTION BASIN FLOW MIX - LOW MAINTENANCE" MIX WHICH WILL PROMOTE POLLUTANT REMOVAL. THE PRIMARY FUNCTION OF THESE BMPs IS TO MANAGE STORMWATER RUNOFF VOLUME AND CONTROL THE PEAK RATE LEAVING THE SITE. PLEASE SEE THE PCSM PLAN AND REPORT FOR DETAILS, SPECIFICATIONS AND CALCULATIONS.

**CONSTRUCTION SEQUENCE**

1. PROTECT INFILTRATION BASIN AREA FROM COMPACTION PRIOR TO INSTALLATION.
2. IF POSSIBLE, INSTALL INFILTRATION BASIN DURING THE LATER PHASES OF SITE CONSTRUCTION TO PREVENT SEDIMENTATION AND/OR DAMAGE FROM CONSTRUCTION ACTIVITY. AFTER INSTALLATION, PREVENT SEDIMENT LADEN WATER FROM ENTERING INLETS AND PIPES.
3. INSTALL AND MAINTAIN PROPER EROSION AND SEDIMENT CONTROL MEASURES DURING CONSTRUCTION.
4. IF NECESSARY, EXCAVATE INFILTRATION BASIN BOTTOM TO AN UNCOMPACTED SUBGRADE FREE FROM ROCK AND DEBRIS. DO NOT COMPACT SUBGRADE.
5. INSTALL OUTLET CONTROL STRUCTURES.
6. SEED AND STABILIZE TOPSOIL. (VEGETATE IF APPROPRIATE WITH NATIVE PLANTINGS)
7. DO NOT REMOVE INLET PROTECTION OR OTHER EROSION AND SEDIMENT CONTROL MEASURES UNTIL SITE IS FULLY STABILIZED.

**MAINTENANCE**

1. WHILE VEGETATION IS BEING ESTABLISHED, PRUNING AND WEEDING MAY BE REQUIRED.
2. DETRITUS MAY ALSO NEED TO BE REMOVED EVERY YEAR. PERENNIAL PLANTINGS MAY BE CUT DOWN AT THE END OF THE GROWING SEASON.
3. AREAS SHOULD BE INSPECTED AT LEAST TWO TIMES PER YEAR FOR SEDIMENT BUILDUP, EROSION VEGETATIVE CONDITIONS ETC.
4. DURING PERIODS OF EXTENDED DROUGHT, AREAS MAY REQUIRE WATERING.

**MAINTENANCE AND INSPECTION**

1. CATCH BASINS AND INLETS (UPGRADEMENT OF INFILTRATION FACILITY) SHOULD BE INSPECTED AND CLEANED AT LEAST TWO TIMES PER YEAR AND AFTER MAJOR RUNOFF EVENTS (> 1-INCH RAINFALL DEPTH)
2. THE VEGETATION ALONG THE SURFACE OF THE INFILTRATION FACILITY SHALL BE MAINTAINED IN GOOD CONDITION, AND ANY BARE SPOTS SHALL BE RE-VEGETATED AS SOON AS POSSIBLE.
3. VEHICLES SHOULD NOT BE PARKED OR DRIVEN OVER AN INFILTRATION AREA, AND CARE SHOULD BE TAKEN TO AVOID EXCESSIVE

**COMPACTION BY MOVERS**

4. INSPECT THE FACILITY AFTER RUNOFF EVENTS AND MAKE SURE THAT RUNOFF DRAINS DOWN WITHIN 72 HOURS. MOSQUITOES SHOULD NOT BE A PROBLEM IF THE WATER DRAINS IN 72 HOURS. MOSQUITOES REQUIRE A CONSIDERABLY LONG BREEDING PERIOD WITH RELATIVELY STATIC WATER LEVELS.
5. ALSO INSPECT FOR ACCUMULATION OF SEDIMENT, DAMAGE TO OUTLET CONTROL STRUCTURES, EROSION CONTROL MEASURES, SIGNS OF WATER CONTAMINATION/SPILLS, AND SLOPE STABILITY IN THE BERMS.
6. THE SEED MIXTURE PLANTED IN THE BOTTOM OF THE BASINS SHALL BE MOVED DOWN TO A HEIGHT OF 8-INCHES WHEN IT REACHES A HEIGHT OF 24-INCHES DURING THE FIRST FULL GROWING SEASON ONLY. IN ALL SUBSEQUENT YEARS, ANY MATERIAL STILL STANDING FROM THE PREVIOUS GROWING SEASON SHALL BE MOVED IN EARLY SPRING TO A HEIGHT OF 2-INCHES PRIOR TO THE CURRENT YEAR'S GROWING REACHING A HEIGHT OF 2-INCHES. THE SEED MIXTURE SHALL NOT BE MOVED AGAIN UNTIL THE FOLLOWING SPRING. IN ALL INSTANCES, CLIPPINGS SHALL BE COMPOSTED OR TAKEN TO AN APPROVED YARD WASTE RECYCLING FACILITY. MOWING SHALL AVOID ALL PLUG PLANTINGS IN THE BASIN BOTTOM (WHEN APPLICABLE).

7. REMOVE ACCUMULATED SEDIMENT FROM BASIN AS REQUIRED. RESTORE ORIGINAL CROSS SECTION AND INFILTRATION RATE.
8. SHOULD ANY INFILTRATION BASIN FAIL TO DEWATER WITHIN A 72-HOUR TIME PERIOD THE OWNER SHALL INVESTIGATE ALTERNATIVE SOLUTIONS.
  - ALTERNATIVES INCLUDE:
    - REPLACE THE ENGINEERED SOIL LAYER AND / OR THE UNDERDRAIN SYSTEM. THE ENGINEERED SOIL LAYER SHOULD BE REMOVED. THE SOIL LAYER AT THE BOTTOM OF THE ENGINEERED SOIL SHALL BE SCARIFIED. THE ENGINEERED SOIL LAYER SHALL BE REPLACED PER THE PCSM PLAN SPECIFICATIONS.
    - CONDUCT AN INVESTIGATION BY A QUALIFIED INDIVIDUAL IN ORDER TO DETERMINE THE CAUSE OF FAILURE AND MAKE A DETERMINATION AS TO THE BEST COURSE OF ACTION AS TO RETURN THE SITE TO THE STANDARDS OF THE LOCAL MUNICIPAL AUTHORITY AND THE PA DEP.

**SWALES**

**OPERATION & MAINTENANCE**

1. MAINTENANCE ACTIVITIES TO BE DONE ANNUALLY AND WITHIN 48 HOURS AFTER EVERY MAJOR STORM EVENT (>1-INCH RAINFALL DEPTH).
  - a. INSPECT AND CORRECT EROSION PROBLEMS, DAMAGE TO VEGETATION, AND SEDIMENT AND DEBRIS ACCUMULATION (ADDRESS WHEN >3 INCHES AT ANY SPOT OR COVERING VEGETATION).
  - b. INSPECT VEGETATION ON SIDE SLOPES FOR EROSION AND FORMATION OF RILLS OR GULLIES. CORRECT AS NEEDED.
  - c. INSPECT FOR POOLS OF STANDING WATER; DEWATER AND DISCHARGE TO AN APPROVED LOCATION AND RESTORE TO DESIGN GRADE.
  - d. MOW AND TRIM VEGETATION TO ENSURE SAFETY, AESTHETICS, PROPER SWALE OPERATION, OR TO SUPPRESS WEEDS AND INVASIVE VEGETATION; DISPOSE OF CUTTINGS IN A LOCAL COMPOSTING FACILITY; MOW ONLY WHEN SWALE IS FREE TO AVOID RUITTING.
  - e. INSPECT FOR LITTER; REMOVE PRIOR TO MOWING.
  - f. INSPECT FOR UNIFORMITY IN A CROSS-SECTION AND LONGITUDINAL SLOPE, CORRECT AS NEEDED.
  - g. INSPECT SWALE INLET (CURB CUTS, PIPES, ETC.) AND OUTLET FOR SIGNS OF EROSION OR BLOCKAGE, CORRECT AS NEEDED.
  - h. WRITTEN REPORTS DOCUMENTING ALL INSPECTIONS, REPAIRS, AND MAINTENANCE ACTIVITIES SHALL BE MAINTAINED ON SITE BY THE PROPERTY OWNER AT ALL TIMES.
2. MAINTENANCE ACTIVITIES TO BE DONE AS NEEDED:
  - a. PLANT ALTERNATIVE GRASS SPECIES IN THE EVENT OF UNSUCCESSFUL ESTABLISHMENT.
  - b. RE-SEED BARE AREAS, INSTALL APPROPRIATE EROSION CONTROL MEASURES WHEN NATIVE SOIL IS EXPOSED OR EROSION CHANNELS ARE FORMING.
  - c. ROTO-TILL AND REPLANT SWALE IF DRAIN DOWN TIME IS MORE THAN 48 HOURS.
  - d. INSPECT AND CORRECT CHECK DAMS WHEN SIGNS OF ALTERED WATER FLOW (CHANNELIZATION, OBSTRUCTIONS, EROSION, ETC.) ARE IDENTIFIED.
  - e. WATER DURING DRY PERIODS, FERTILIZE, AND APPLY PESTICIDE ONLY WHEN ABSOLUTELY NECESSARY.

**WINTER CONDITIONS ALSO NECESSITATE ADDITIONAL MAINTENANCE CONCERNS, WHICH INCLUDE THE FOLLOWING:**

- a. INSPECT SWALE IMMEDIATELY AFTER SPRING MELT, REMOVE RESIDUALS (E.G. SAND) AND REPLACE DAMAGED VEGETATION WITHOUT DISTURBING REMAINING VEGETATION.
- b. IF ROADSIDE OR PARKING LOT RUNOFF IS DIRECTED TO THE SWALE, MULCHING AND/OR SOIL AERATION/MANIPULATION MAY BE REQUIRED IN THE SPRING TO RESTORE STRUCTURE AND MOISTURE CAPACITY AND TO REDUCE THE IMPACTS OF DEICING AGENTS.
- c. USE NONTOXIC, ORGANIC DEICING AGENTS, APPLIED EITHER AS BLENDED, MAGNESIUM CHLORIDE-BASED LIQUID PRODUCTS OR AS PRETREATED SALT.
- d. USE SALT-TOLERANT VEGETATION IN SWALES.

**OVERALL PCSM CONSTRUCTION SEQUENCE**

1. AT LEAST 7 DAYS BEFORE STARTING ANY EARTH DISTURBANCE ACTIVITIES, INCLUDING CLEARING AND GRUBBING, THE OWNER AND/OR OPERATOR SHALL INVITE ALL CONTRACTORS, THE LANDOWNER, ALL APPROPRIATE MUNICIPAL OFFICIALS, THE E&S PLAN PREPARER, PCSM PLAN PREPARER, THE LICENSED PROFESSIONAL RESPONSIBLE FOR OVERSIGHT OF CRITICAL STAGES OF IMPLEMENTATION OF THE PCSM PLAN, AND A REPRESENTATIVE OF THE COUNTY CONSERVATION DISTRICT TO AN ON-SITE PRE-CONSTRUCTION MEETING.
2. INSTALL PERIMETER E&S CONTROLS (SEE CONSTRUCTION SEQUENCE).
3. INSTALL INFILTRATION BASINS 1 & 2. CARE SHOULD BE TAKEN TO MINIMIZE SOIL COMPACTION IN THESE AREAS BEFORE AND AFTER CONSTRUCTION. SUCCESS HAS BEEN ACHIEVED WITH MINIMAL COMPACTION UTILIZING A "ROCK SLINGER".
4. INSTALL SWALES AND STORM SEWER.
5. CONSTRUCT IMPROVEMENTS. AFTER THE IMPROVEMENTS ARE CONSTRUCTED ADD TOPSOIL TO THE POST-CONSTRUCTION PERVIOUS AREAS TO BE PERMANENTLY STABILIZED.
6. APPLY THE SPECIFIED PERMANENT STABILIZATION ACROSS THE SITE.

**NPDES PERMIT NOTES**

1. PER NPDES REQUESTING A RENEWAL OF COVERAGE UNDER GENERAL PERMIT MUST SUBMIT TO THE COUNTY CONSERVATION DISTRICT AN ADMINISTRATIVELY COMPLETE AND ACCEPTABLE NOI, AT LEAST 90 DAYS PRIOR TO THE EXPIRATION DATE OF THE COVERAGE.
2. PERMITTEE'S REQUESTING A RENEWAL OF COVERAGE UNDER INDIVIDUAL PERMIT MUST SUBMIT TO THE COUNTY CONSERVATION DISTRICT AN ADMINISTRATIVELY COMPLETE AND ACCEPTABLE NOI, AT LEAST 180 DAYS PRIOR TO THE EXPIRATION DATE OF THE COVERAGE.
3. ALL EARTHMOVING CONTRACTORS MUST BE ADDED AS CO-PERMITTEES TO THE NPDES PERMIT.
4. SITE INSPECTIONS AND MONITORING REPORTS - THE PERMITTEE AND CO-PERMITTEE(S) SHALL COMPLY WITH ALL OF THE MONITORING AND REPORTING REQUIREMENTS IN PART 4.2 OF THE NPDES PERMIT. THE PERMITTEE AND CO-PERMITTEE(S) SHALL ENSURE THAT SITE INSPECTIONS ARE CONDUCTED AT LEAST WEEKLY AND AFTER EACH MEASURABLE PRECIPITATION EVENT BY QUALIFIED PERSONNEL. A WRITTEN REPORT SHALL BE KEPT FOR EACH INSPECTION IN ACCORDANCE WITH THE REQUIREMENTS OF PART 4.2 A.
5. THE DEP "VISUAL INSPECTION CHECKLIST" SHOULD BE COMPLETED FOR EACH INSPECTION AND SHOULD BE AVAILABLE ON-SITE FOR INSPECTION BY DEP OR COUNTY CONSERVATION DISTRICT PERSONNEL.
6. AFTER ALL EARTHMOVING ACTIVITY HAS CEASED AND THE ENTIRE PERMITTED AREA IS PERMANENTLY STABILIZED, THE PERMITTEE MUST SUBMIT A NOTICE OF TERMINATION TO THE LOCAL COUNTY CONSERVATION DISTRICT TO CLOSE OUT THE PERMIT. ALLOWING THE NPDES PERMIT TO EXPIRE IS DETERMINED TO BE A VIOLATION OF THE NPDES PERMIT.

**BMP CRITICAL STAGES**

PER REQUIREMENTS OF THE PA DEP A LICENSED PROFESSIONAL OR DESIGNEE MUST BE PRESENT FOR THE INSTALLATION OF ALL BMP AND STORMWATER CONTROLS. PLEASE CONTACT THE DESIGN PROFESSIONAL OR ENSURE A LICENSED PROFESSIONAL IS PRESENT BEFORE BEGINNING THE FOLLOWING CONSTRUCTION ACTIVITIES:


- PERMANENT SITE STABILIZATION
- INFILTRATION BASINS 1 & 2
  - EXCAVATION/ROUGH GRADING
  - OUTLET PIPE, ANTI-SEEP COLLAR, CLAY CORE INSTALLATION
  - UNDERDRAIN AND AMENDED SOLS INSTALLATION

**PROJECT WASTES NOTES**


THE CONTRACTOR SHALL NOT ILLEGALLY BURY, DUMP, OR DISCHARGE ANY BUILDING MATERIAL, OR WASTES ON OR OFF THE SITE. THESE BUILDING WASTES INCLUDE, BUT ARE NOT LIMITED TO, EXCESS SOIL MATERIALS, BUILDING MATERIALS, CONCRETE WASH WATER, SANITARY WASTES, EXISTING ON-SITE REFUSE, ETC. THAT COULD ADVERSELY IMPACT WATER QUALITY. ALL BUILDING MATERIALS AND WASTES SHALL BE REMOVED FROM THE SITE AND RECYCLED OR DISPOSED OF IN AN APPROVED YARD WASTE MANAGEMENT REGULATIONS AT 25 PA CODE 260.1 ET SEQ. 271.1 ET SEQ. NO BUILDING MATERIALS OR WASTES SHALL BE BURNED, BURIED, DUMPED, OR DISCHARGED AT




PIPE NO.	PIPE DIA. Do (in.)	RIPRAP SIZE	Rt (ft)	Al (ft)	Alw (ft)	Atw (ft)
EX-EW-1	18	R-4	18	12	5	17
FES-11	12	R-6	36	9	3	7
EW-2	36	R-5	27	13	9	14
EW-1 (2b)	18	R-4	18	10	9	13
FES-12	12	R-6	36	9	3	7

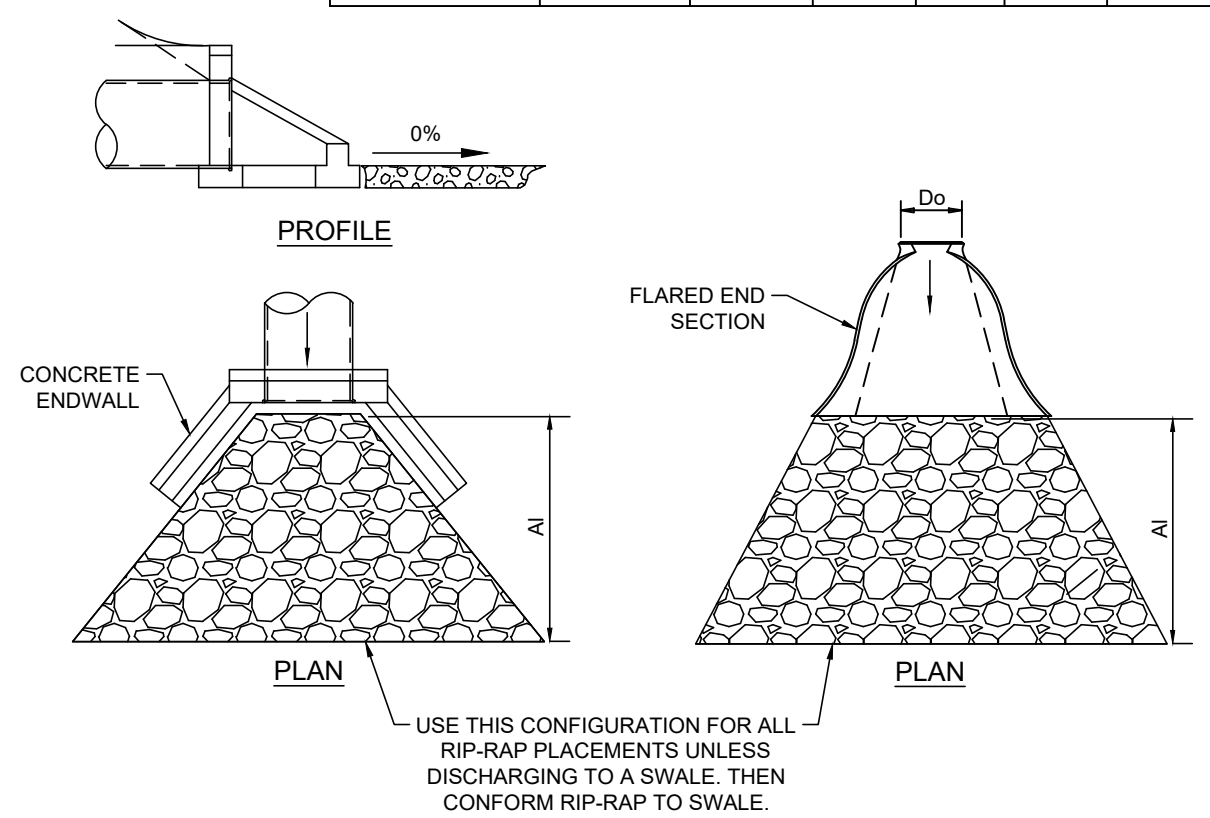


**FLARED END SECTION/ENDWALL RIP RAP DETAIL**  
NO SCALE

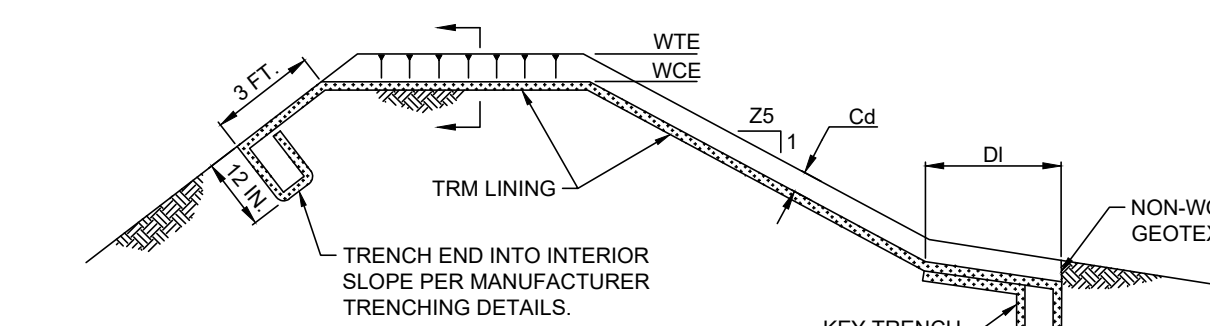

BASIN NO.	WEIR			CREST ELEV WCE (FT)	WIDTH Ww (FT)	TRM TYPE	STAPLE PATTERN	CHANNEL DEPTH Cd (FT)	LENGTH Dl (FT)	WIDTH Dd (FT)	RIPRAP SIZE (R-L)	RIPRAP THICK DRI (IN)
	Z3 (FT)	Z4 (FT)	Z4 ELEV WTE (FT)									
1	3	3	449.00	447.00	100	S200	E	3	2.00	15	N/A	N/A
2	3	3	451.50	449.75	40	S200	E	3	1.75	15	N/A	N/A

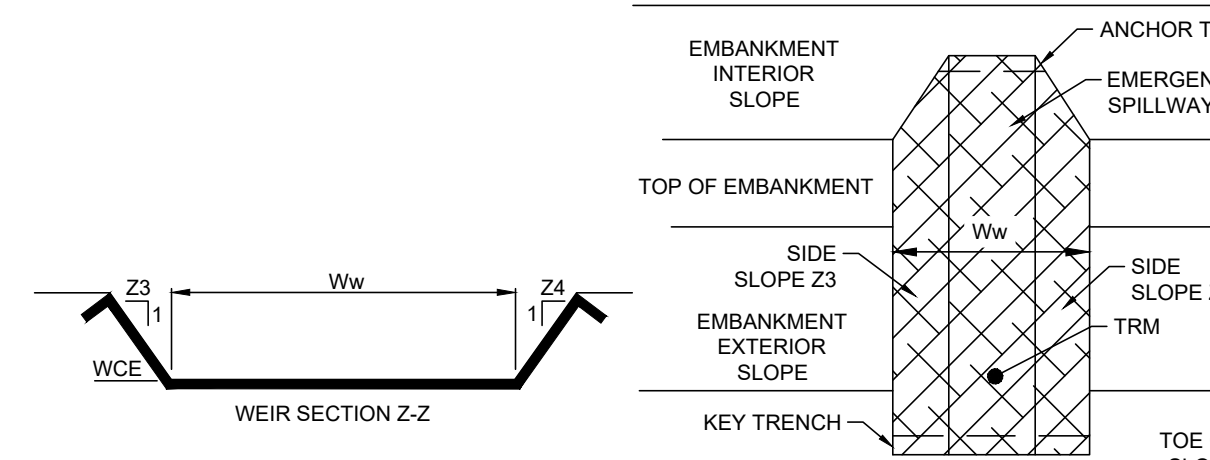


**BASIN EMERGENCY SPILLWAY DETAIL**  
NO SCALE

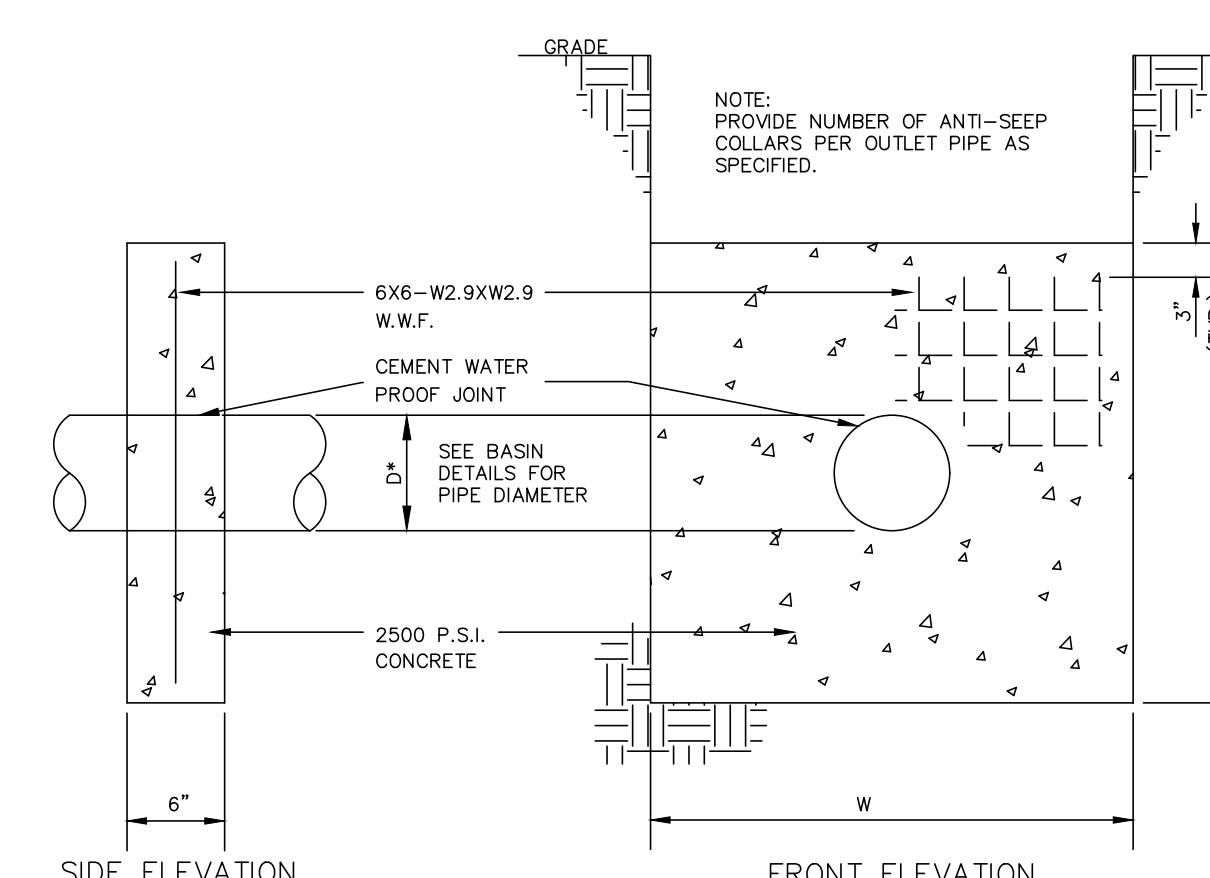


BASIN	W	H	DIA.	# OF COLLARS
1	3.98'	3.98'	18"	2
2	3.35'	3.35'	18"	2

**CONCRETE ANTI-SEEP COLLAR DETAIL**  
NO SCALE

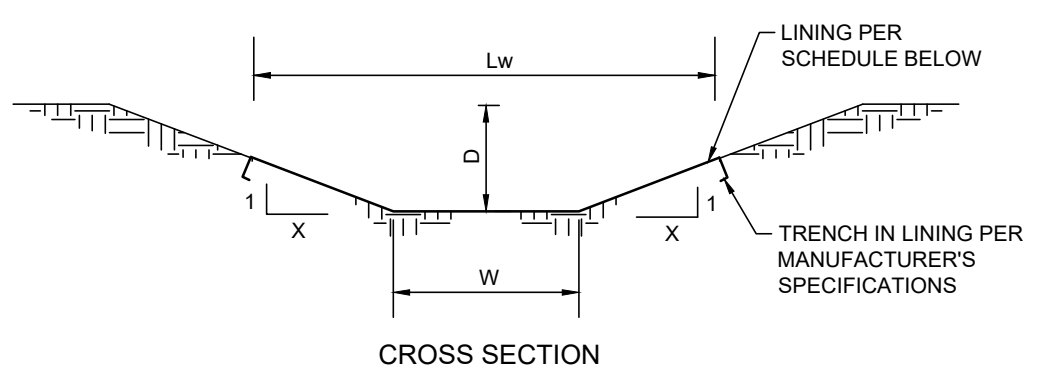


SWALE NO.	WIDTH (W)	DEPTH (D)	SIDE SLOPE (X)	MAX. SLOPE	LINING WIDTH (Lw)	LINING	TEMPORARY LINING	STAPLE PATTERN
A	2'	1'	4:1	4%	10'	GRASS	N.A.G. S75	D
B	2'	1'	5:1	1%	12'	GRASS	N.A.G. S75	D
C	1.5'	1'	5:1	2%	11.5'	GRASS	N.A.G. S75	D
D	3'	1'	3:1	1.5%	N/A	GRASS	N/A	N/A
E	1.5'	1'	3:1	5%	7.5'	GRASS	N.A.G. S75	D


**STORMWATER SWALE DETAIL**  
NO SCALE

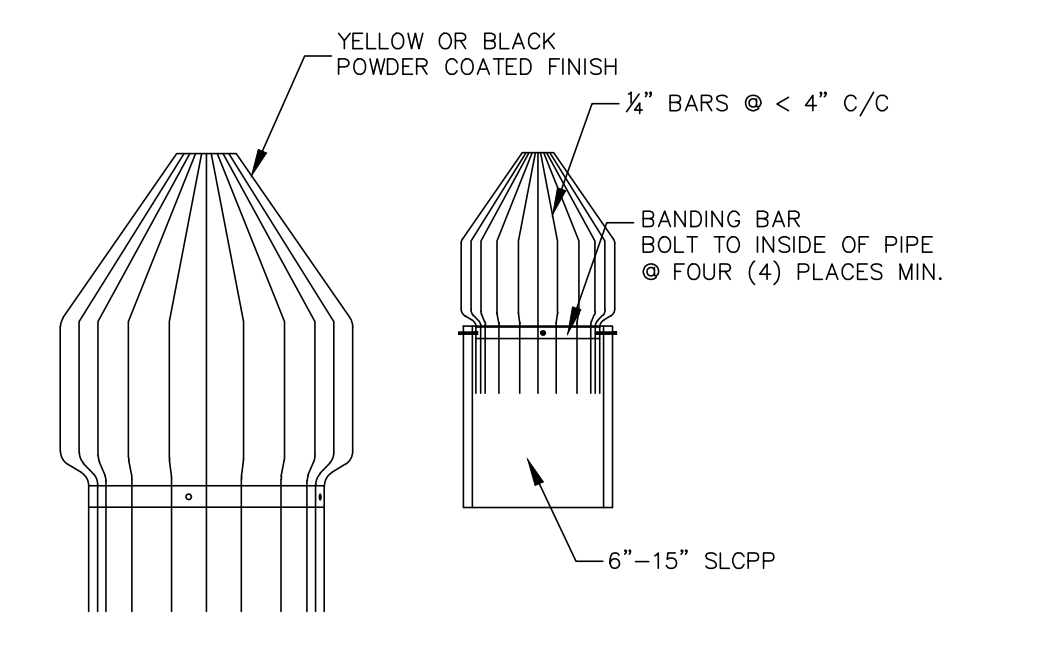


**BAR GUARD DETAIL**  
NO SCALE

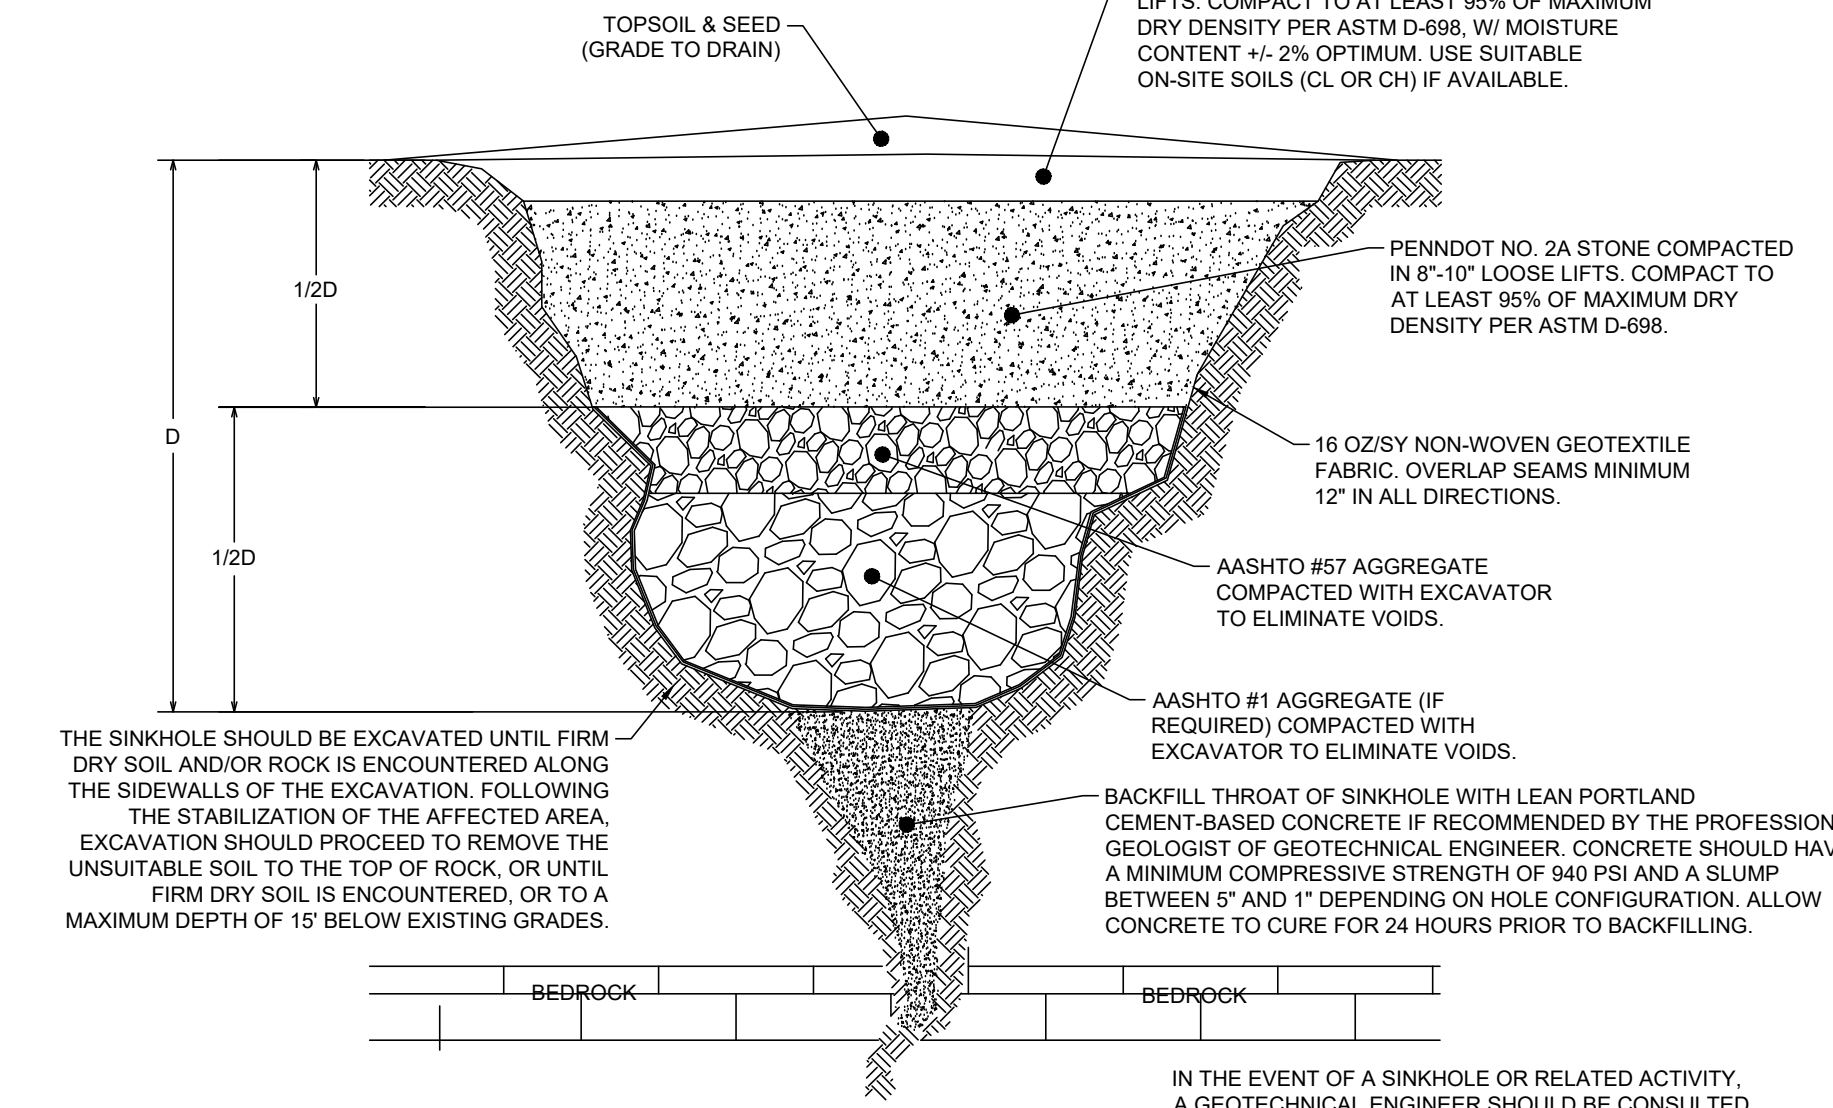

**SINKHOLE REPAIR DETAIL-BEDROCK THROAT NOT ENCOUNTERED**  
NO SCALE

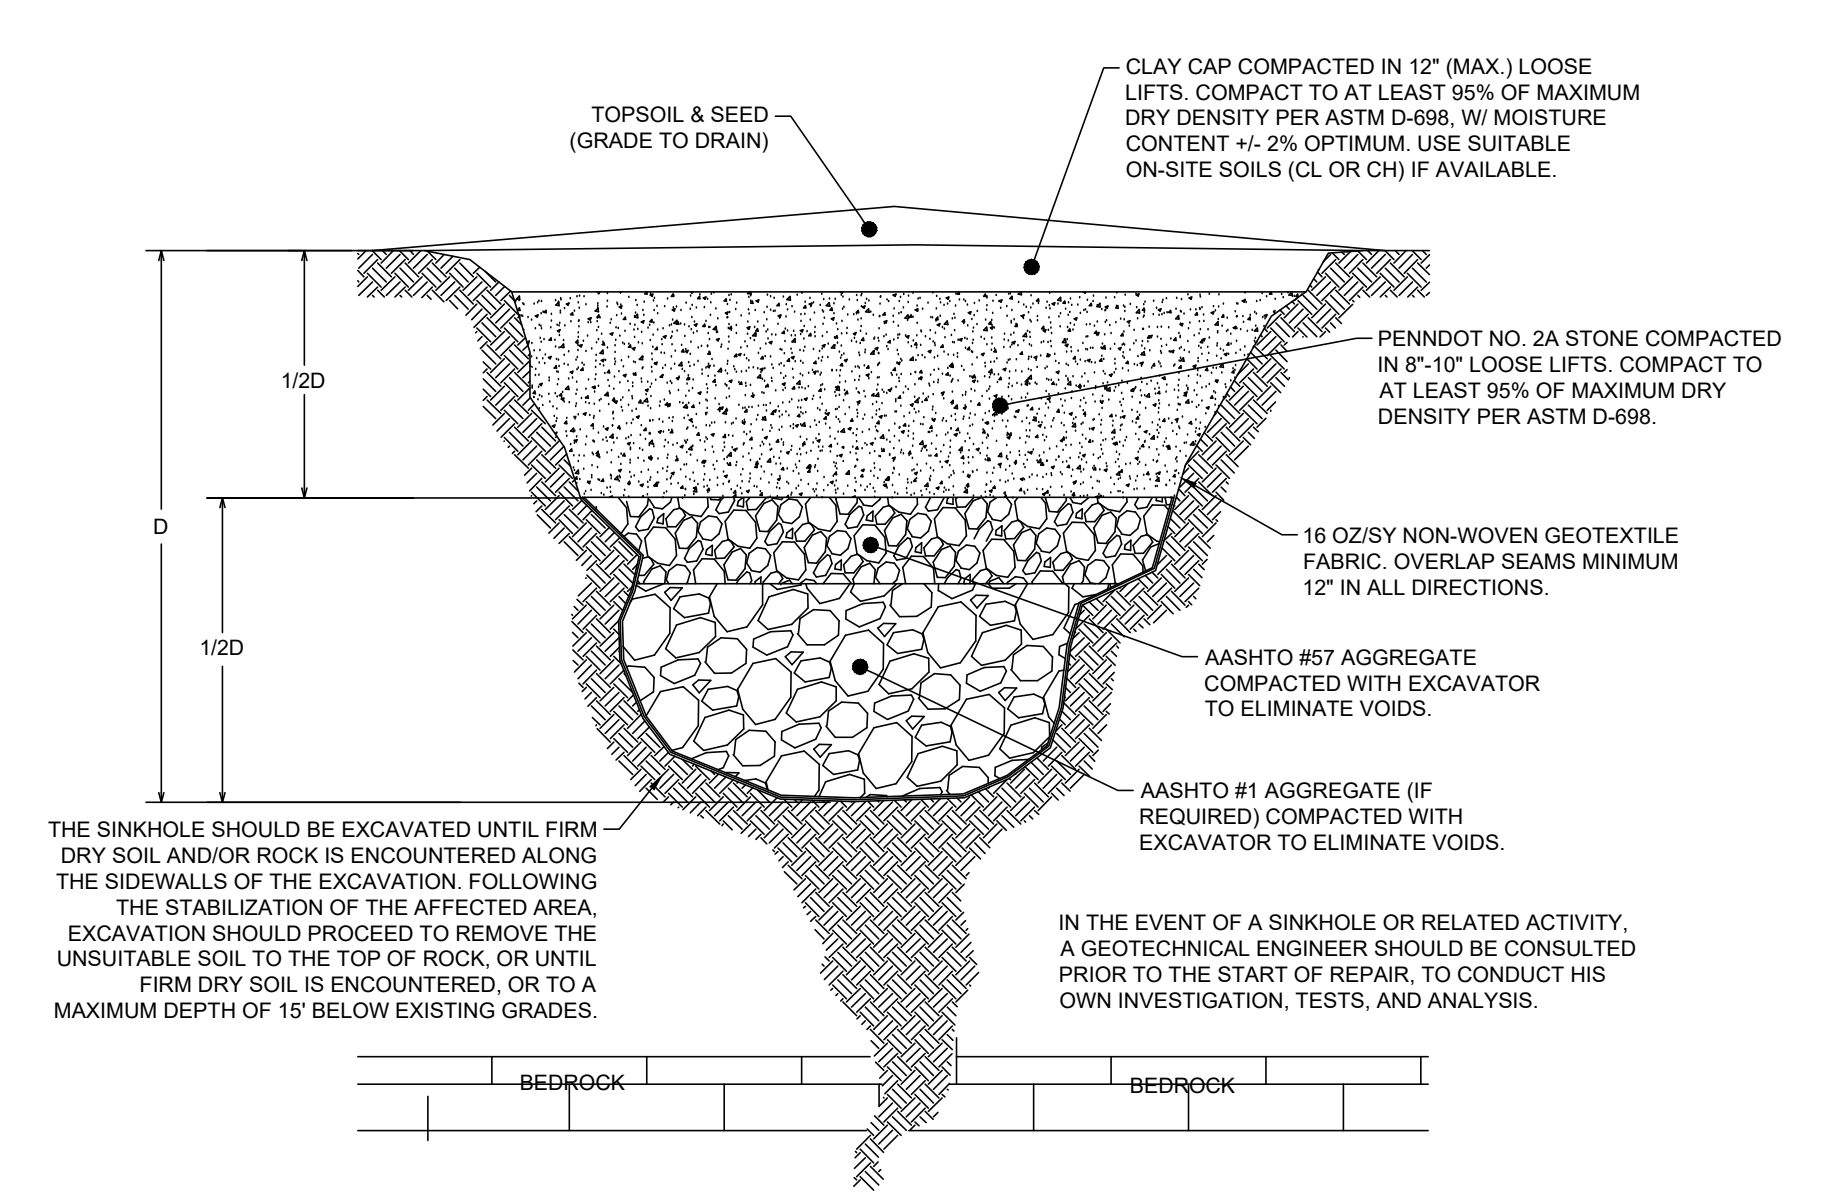


**SINKHOLE REPAIR DETAIL-BEDROCK THROAT ENCOUNTERED**  
NO SCALE

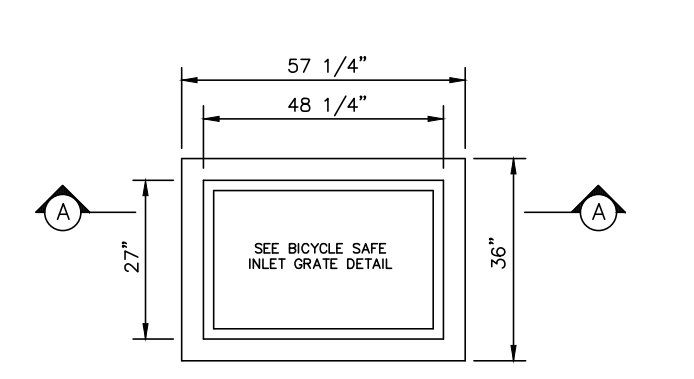


SECTION	WIDTH	DEPTH	DIAMETER
A-A	45 1/4"	1 1/2"	1 1/2"


**TYPE M INLET DETAIL (RC-45M)**  
NO SCALE

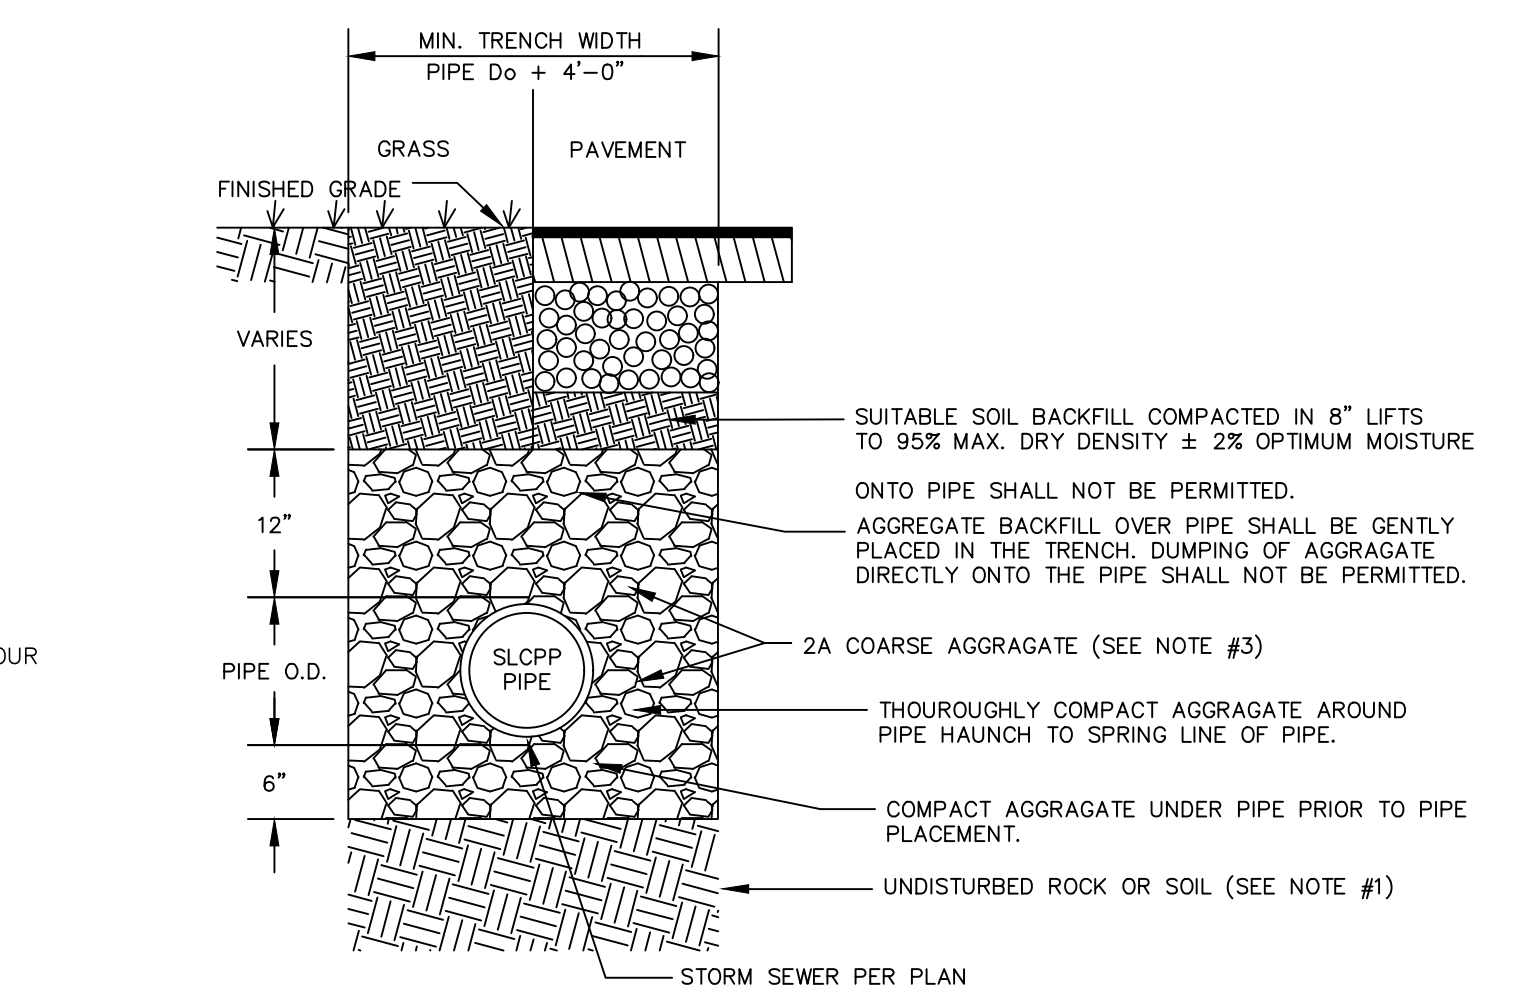


**TYPICAL TRENCH DETAIL FOR SLCPP INSTALLATION**  
NO SCALE

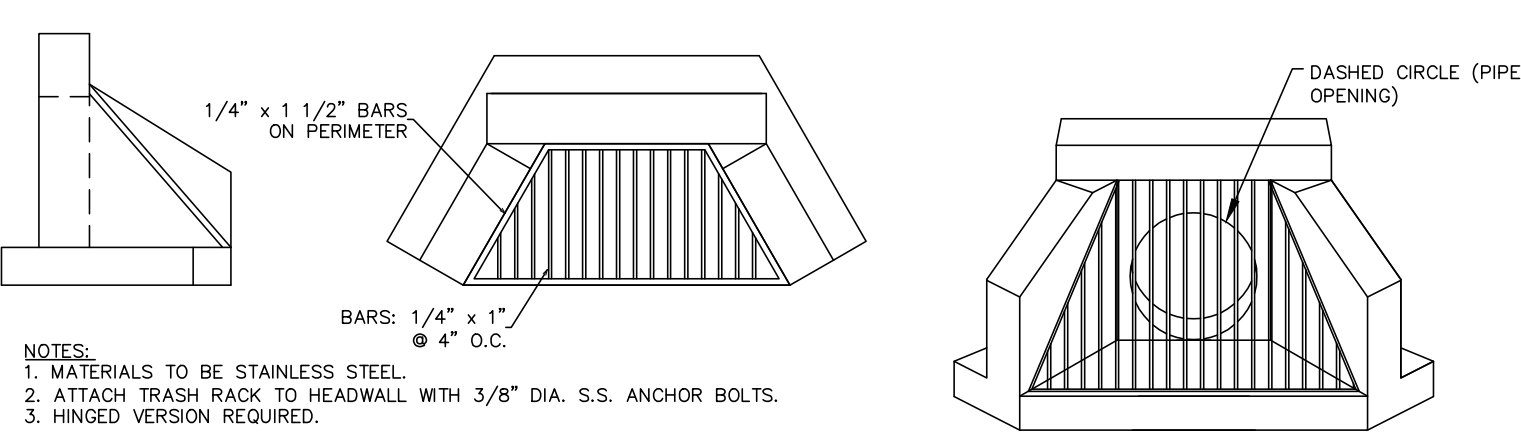


**TYPE DW ENDWALL WITH TRASH RACK DETAIL**  
NO SCALE

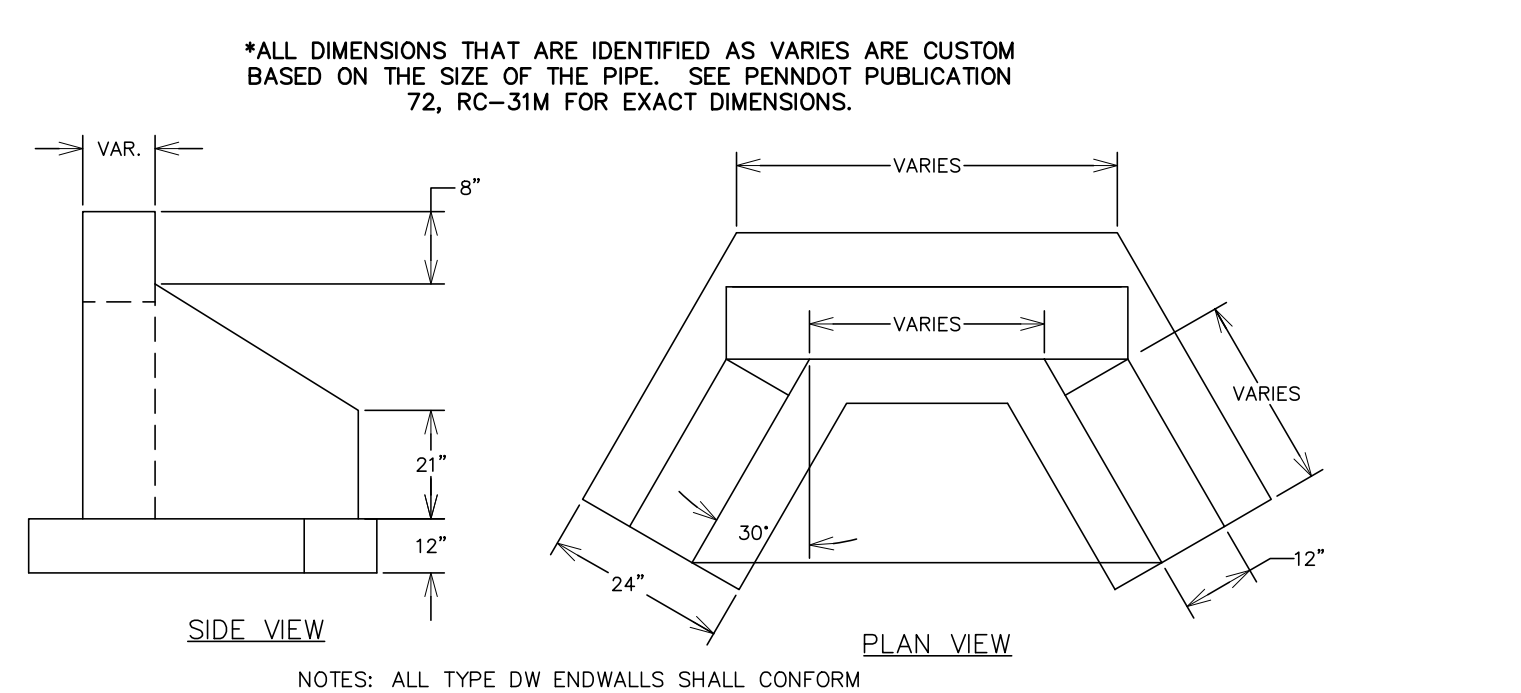


**TYPE DW ENDWALL DETAIL**  
NO SCALE

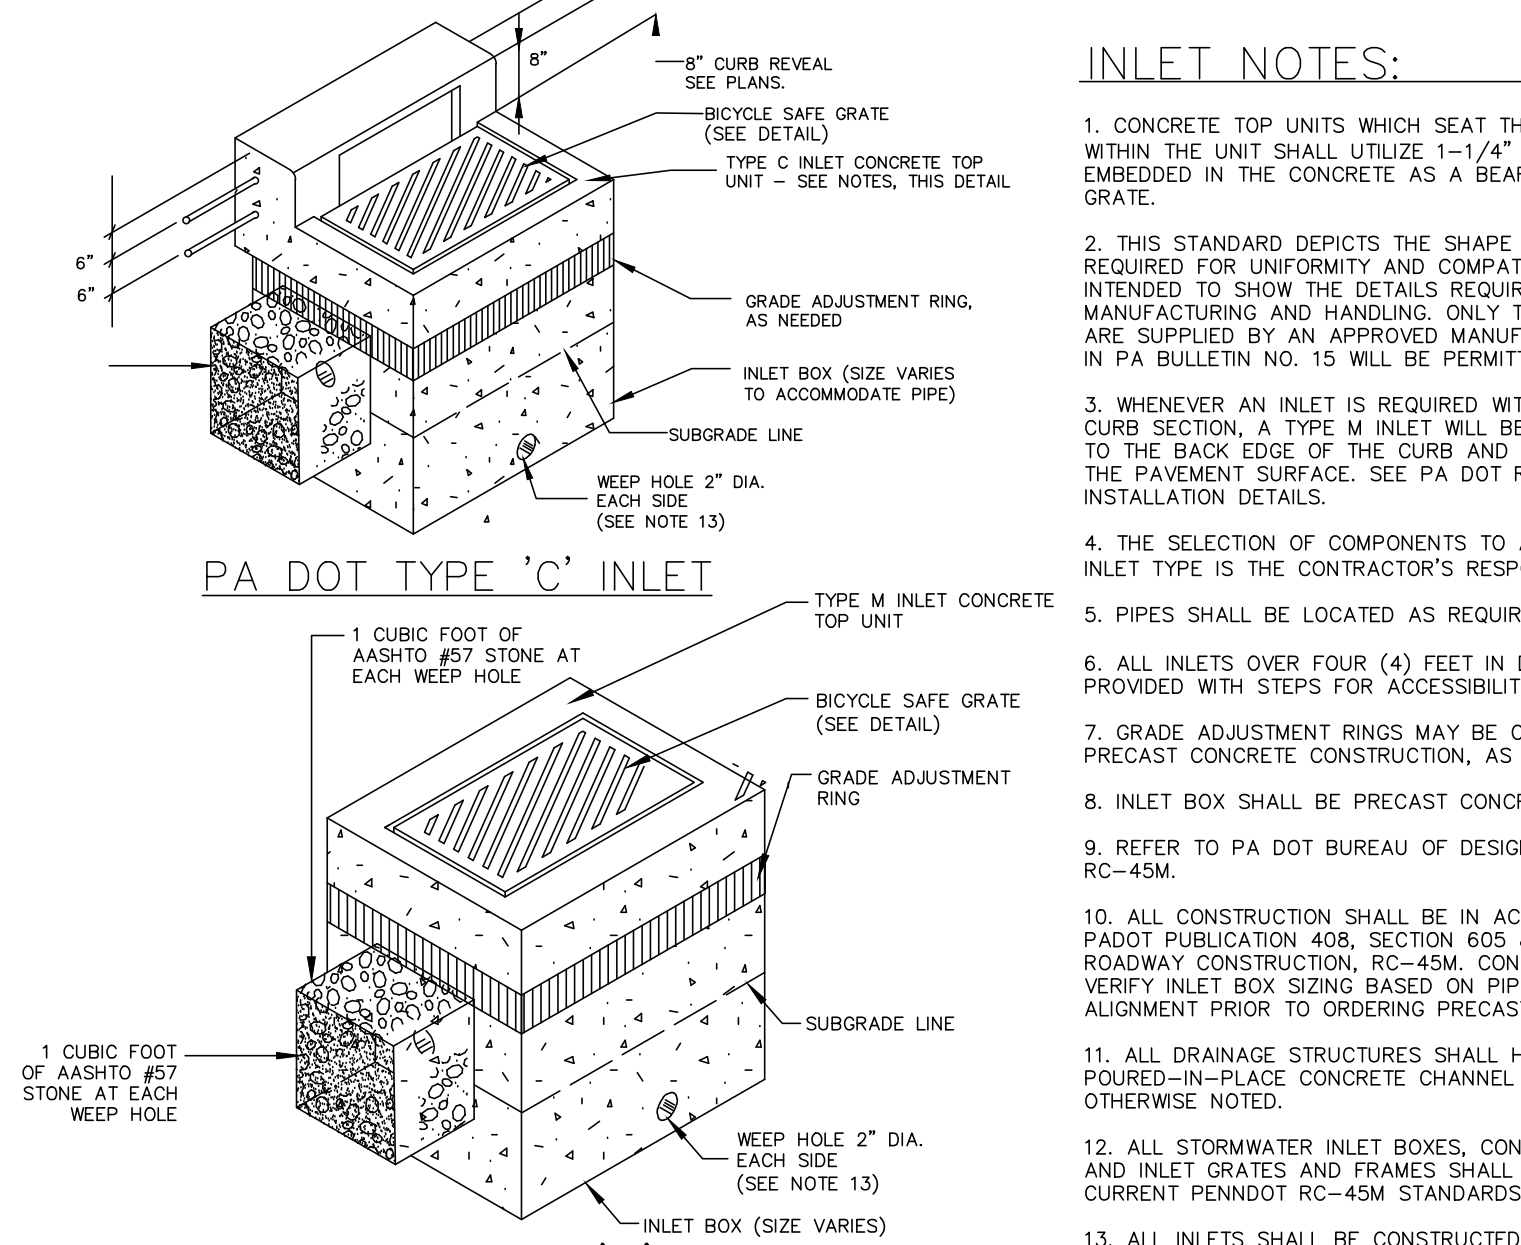


**PADOT STORMWATER INLETS (TYPE C & M)**  
NO SCALE

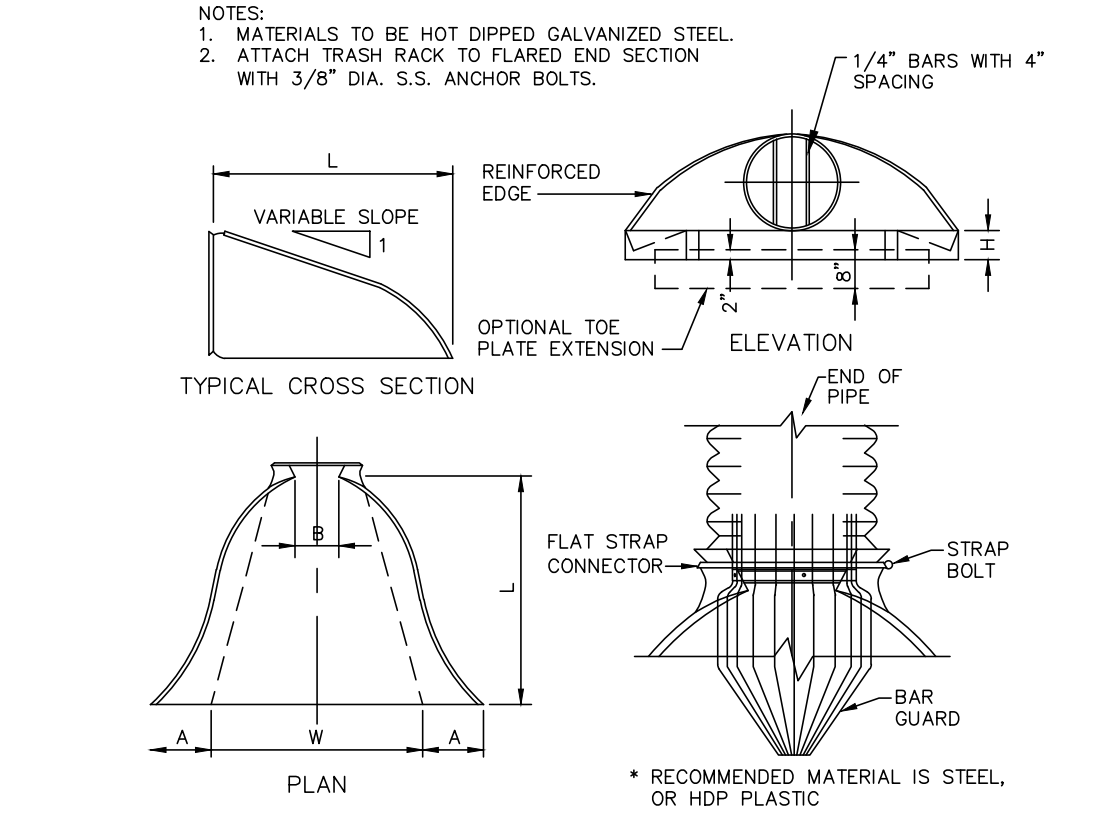


**FLARED END SECTION DETAIL**  
NO SCALE

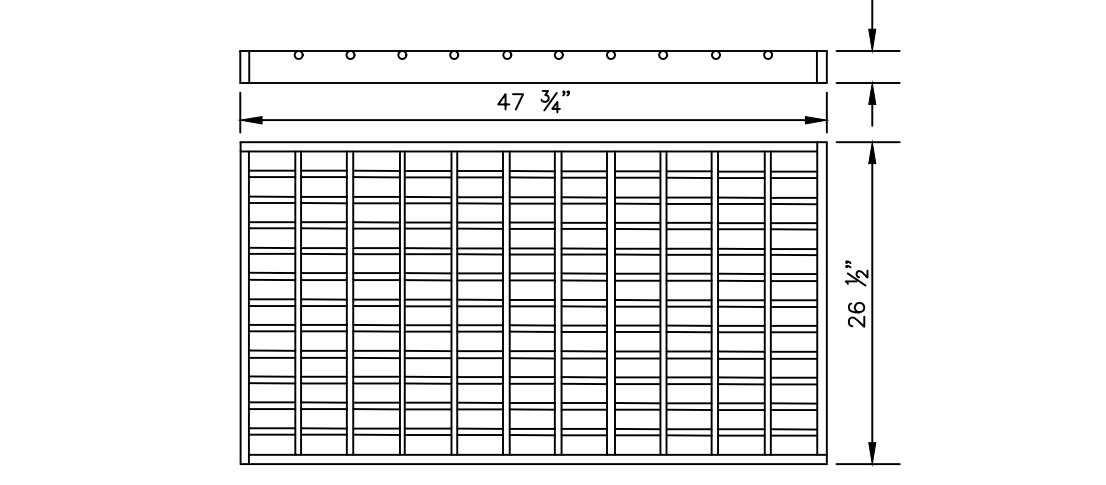

**TYPICAL STEEL GRATE-BICYCLE SAFE**  
NO SCALE

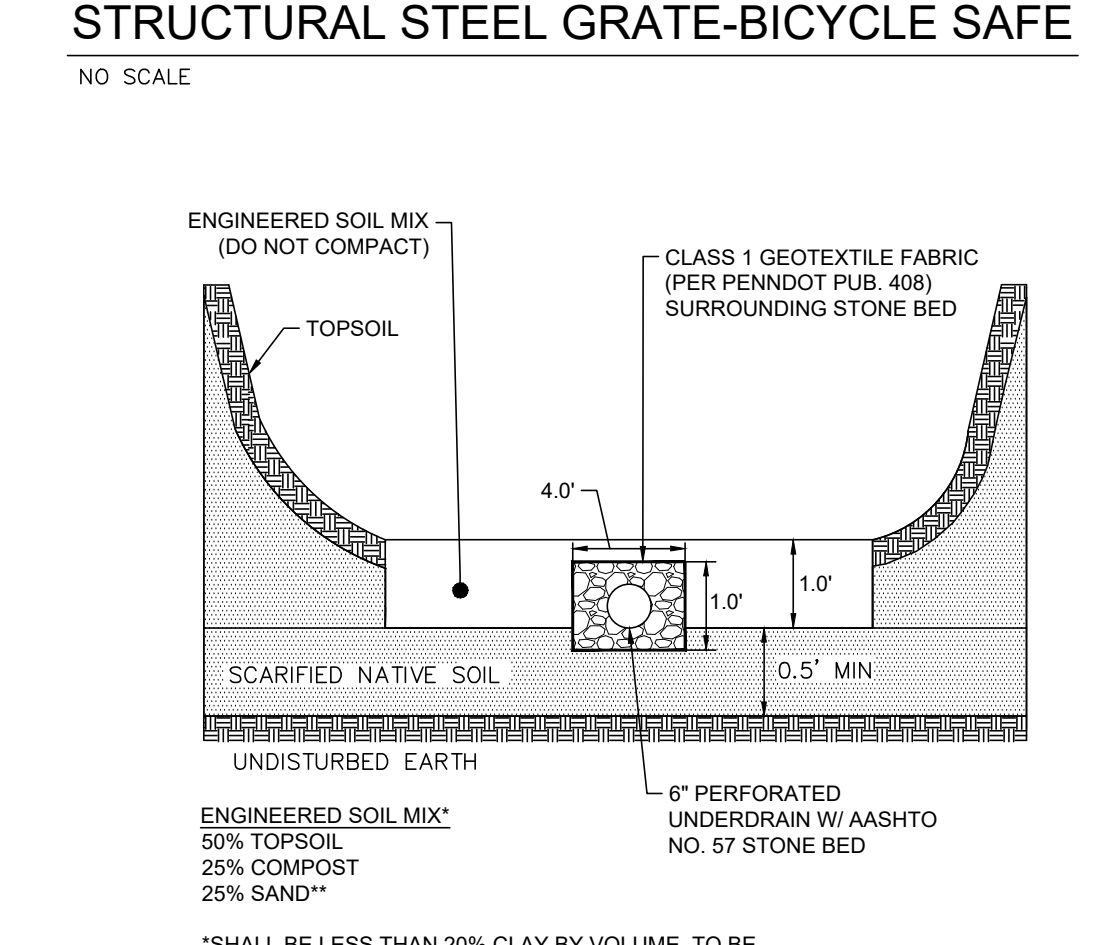

**INFILTRATION BASIN BOTTOM TYPICAL CROSS SECTION DETAIL**  
NO SCALE

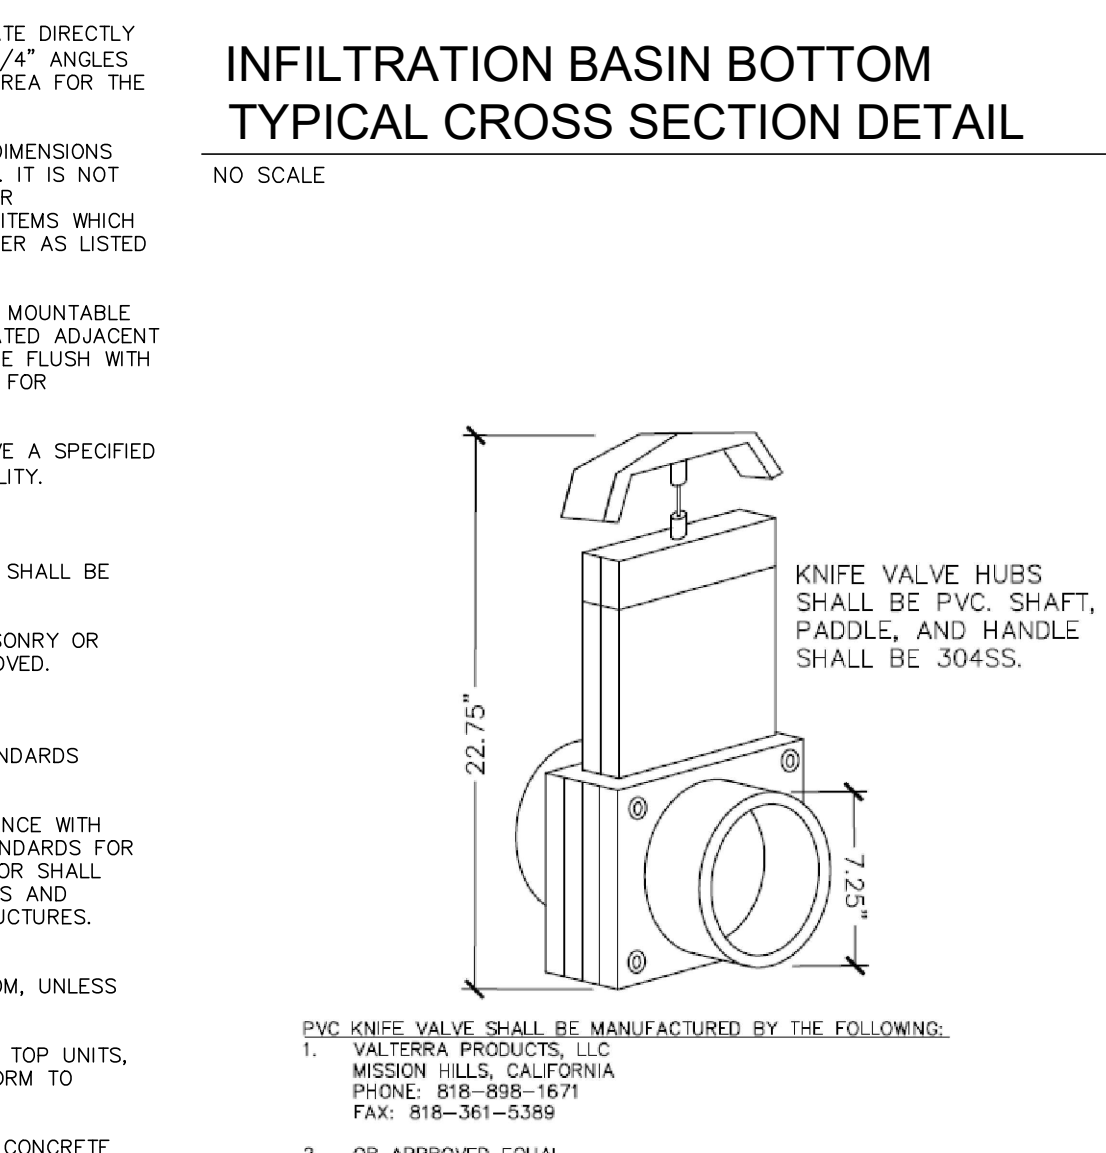

**2\"/>**


NO.	DATE	BY	REVISION

NO.	DATE	BY	REVISION

**POST CONSTRUCTION STORMWATER MANAGEMENT DETAILS**  
**PRELIMINARY/FINAL LAND DEVELOPMENT PLANS**  
For  
**SCOUT COLD LOGISTICS, LLC**  
located in  
NORTH LEBANON TOWNSHIP  
LEBANON County, Pennsylvania


Streetside Engineering & Surveying, Inc.  
279 Lebanon, Pennsylvania 17042  
Phone: (717) 272-7110  
Fax: (717) 272-7348

FIELD CREW: MOD/JEC  
BASE MAP: JEC  
DRAWN: CDS  
DESIGN: CDS  
CHECKED: SAS  
DATE: 02/26/24  
SCALE: AS NOTED  
PROJECT # 2368-23-001

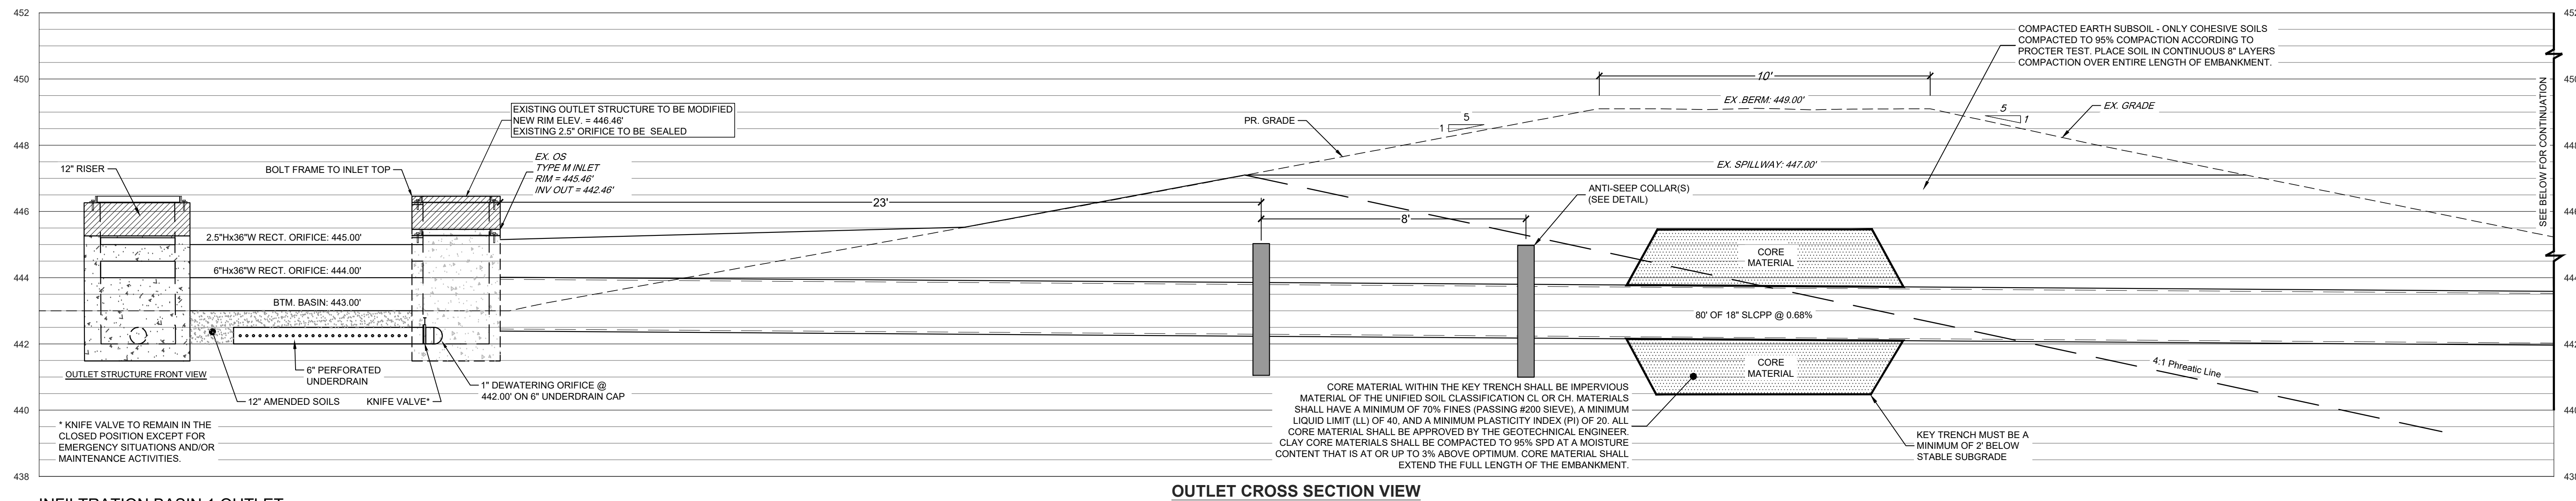


**INFILTRATION BASIN 1 OUTLET**  
SCALE: 1" = 2.5'

**OUTLET CROSS SECTION VIEW**

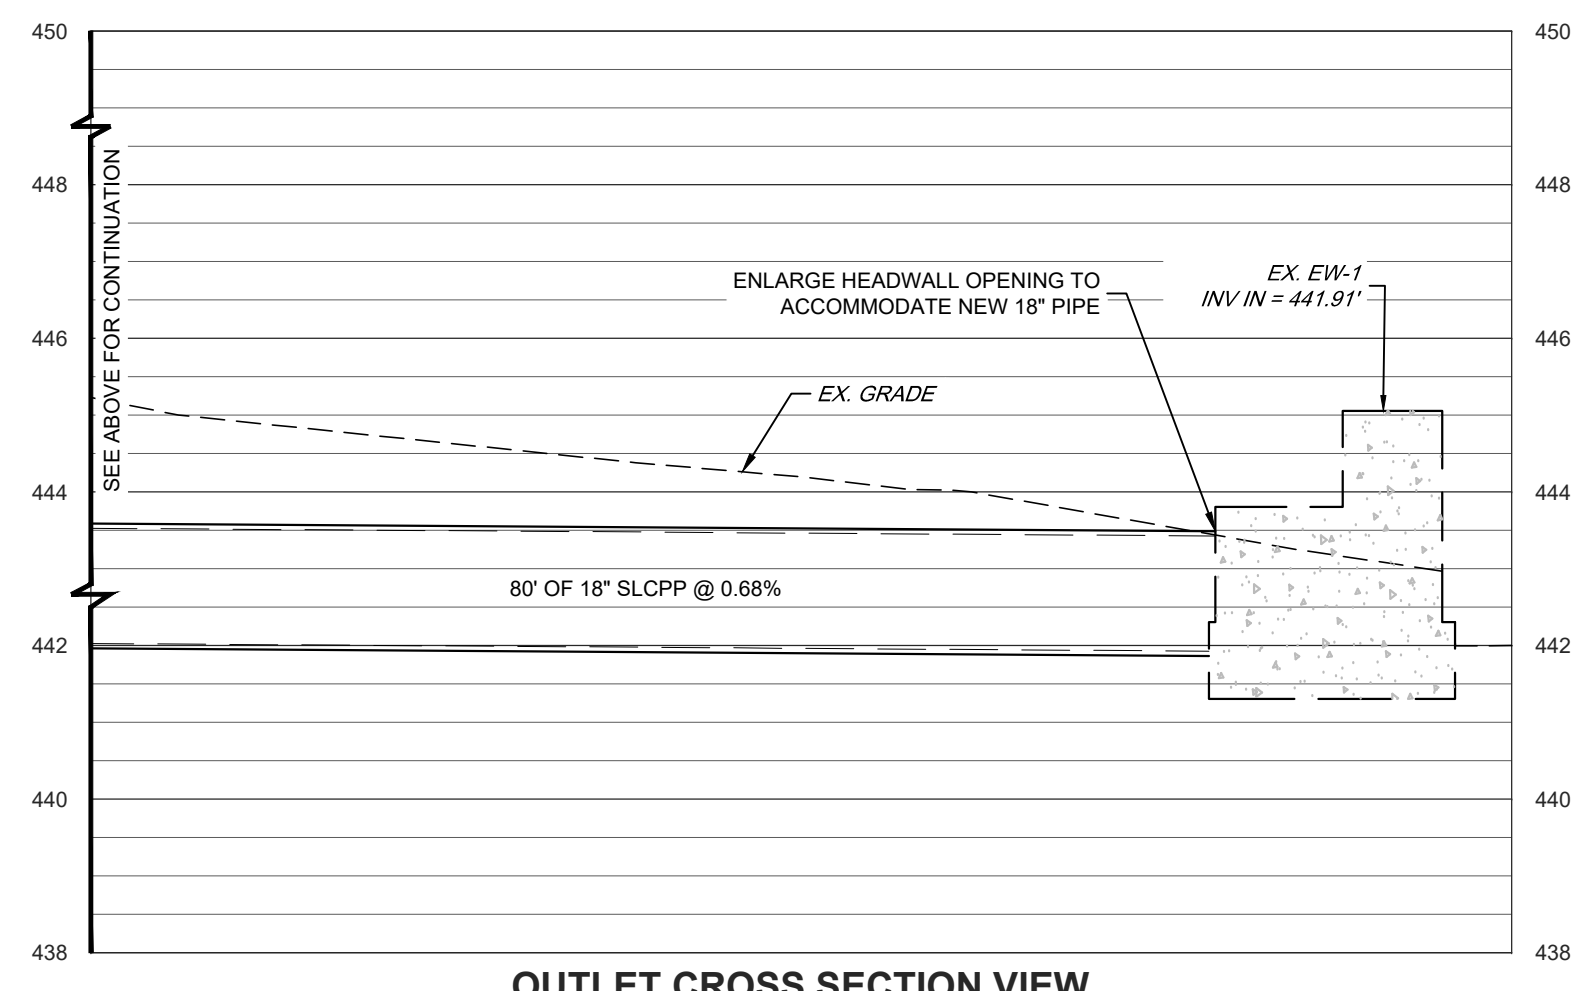


**INFILTRATION BASIN 1 OUTLET CON'T**  
SCALE: 1" = 2.5'

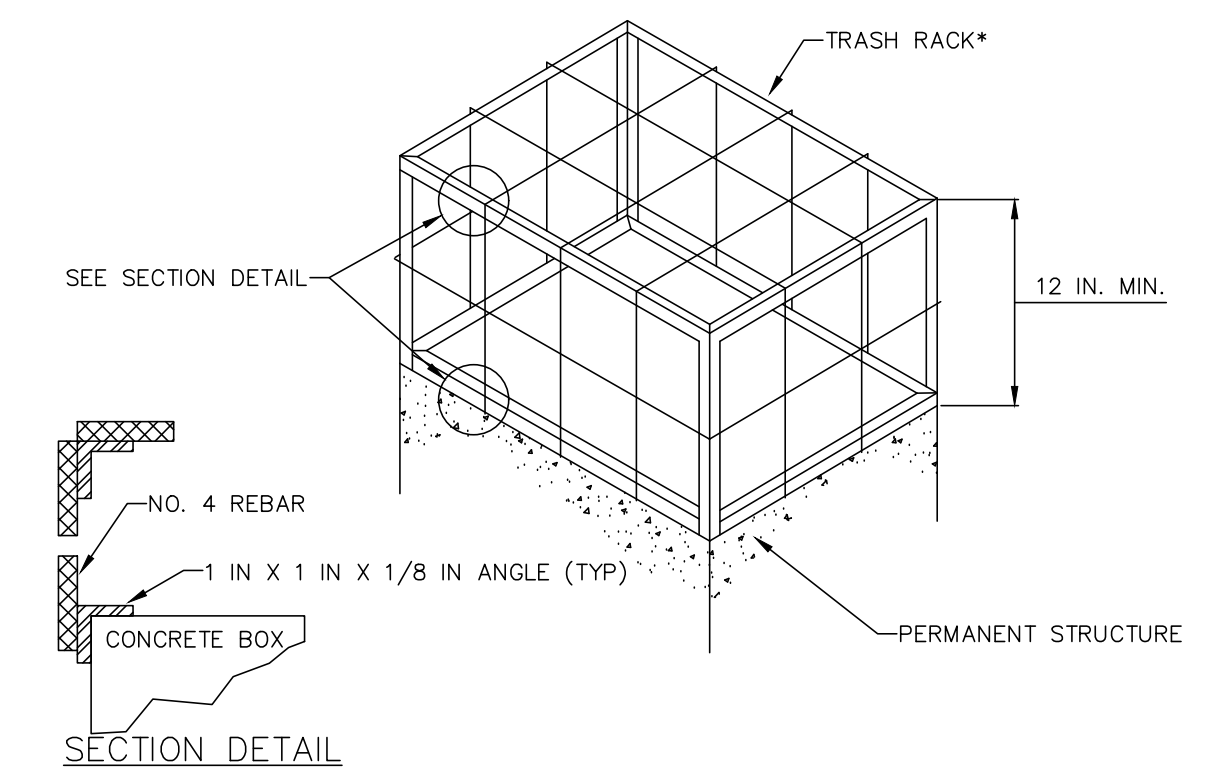


**NOTES:**  
ALL JOINTS SHALL BE WATER TIGHT.  
CLOGGED OR DAMAGED SPILLWAYS SHALL BE REPAIRED IMMEDIATELY. TRASH AND OTHER DEBRIS SHALL BE REMOVED FROM THE BASIN AND RISER.  
TRASH RACK MAY BE REMOVED AFTER CONVERSION FROM SEDIMENT BASIN TO PERMANENT STORMWATER BASIN.


**TRASH RACK FOR PERMANENT STRUCTURE DETAIL**  
NO SCALE

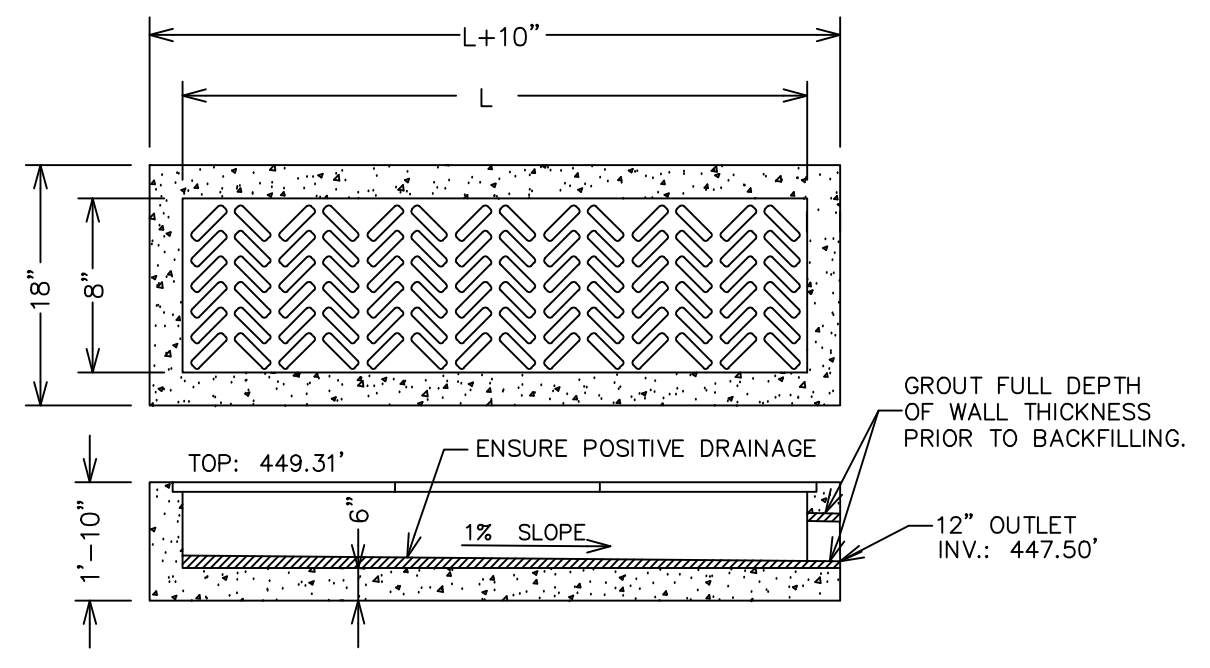

**TRENCH DRAIN TYPICAL DETAIL**  
NO SCALE

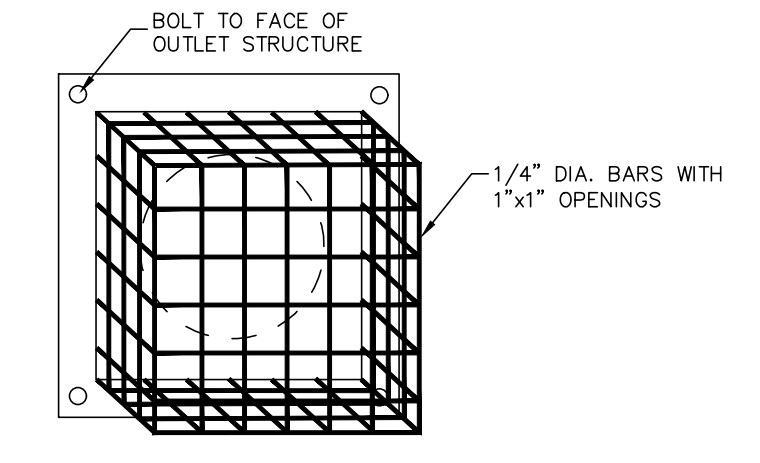


**ORIFICE TRASH RACK DETAIL**  
NO SCALE

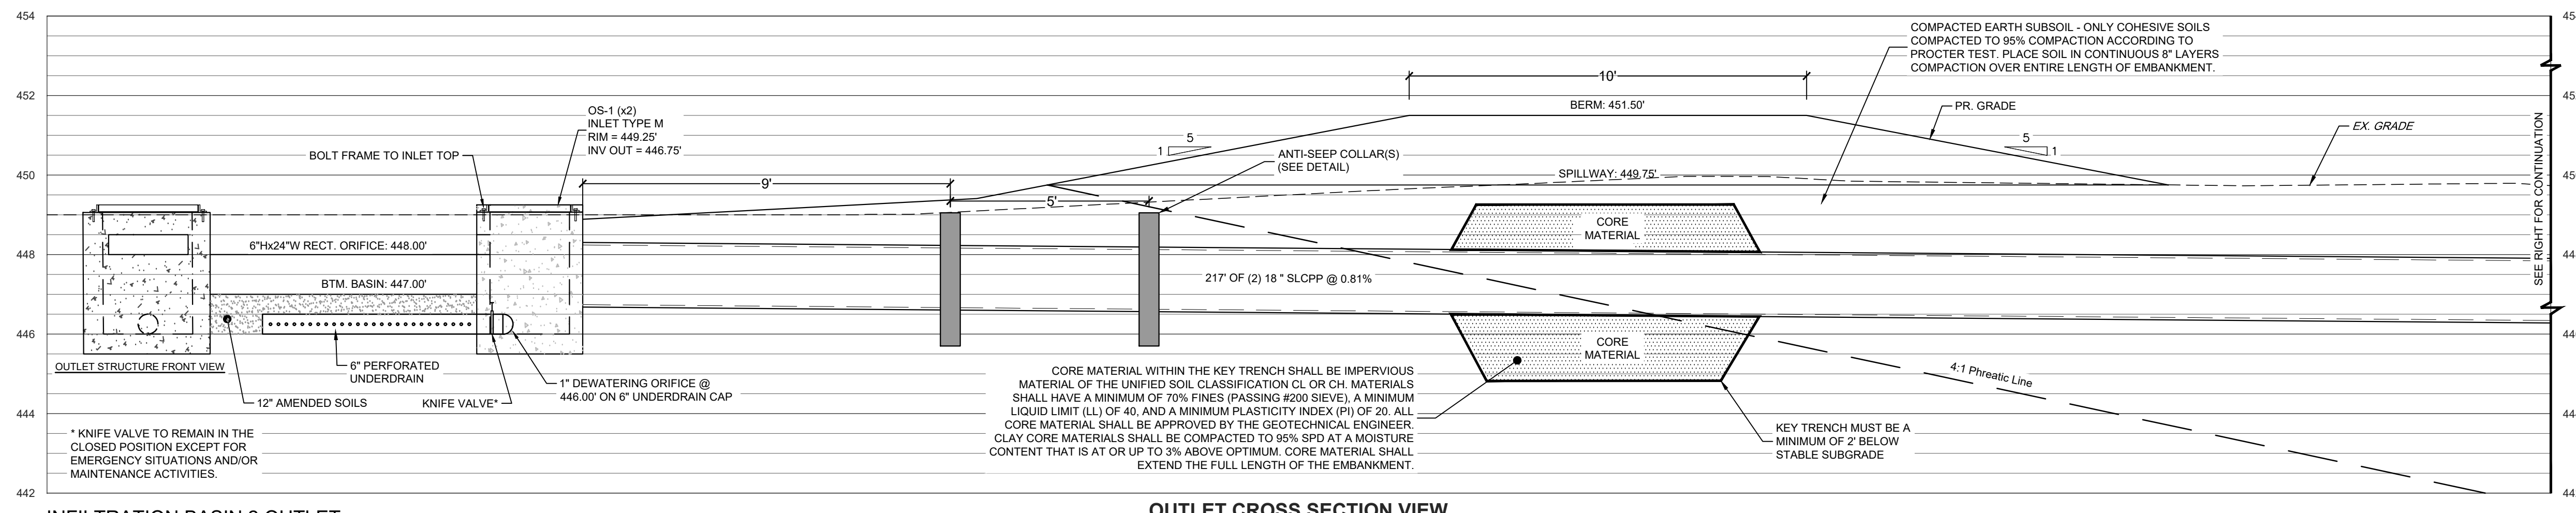

**INFILTRATION BASIN 2 OUTLET**  
SCALE: 1" = 2.5'


**OUTLET CROSS SECTION VIEW**

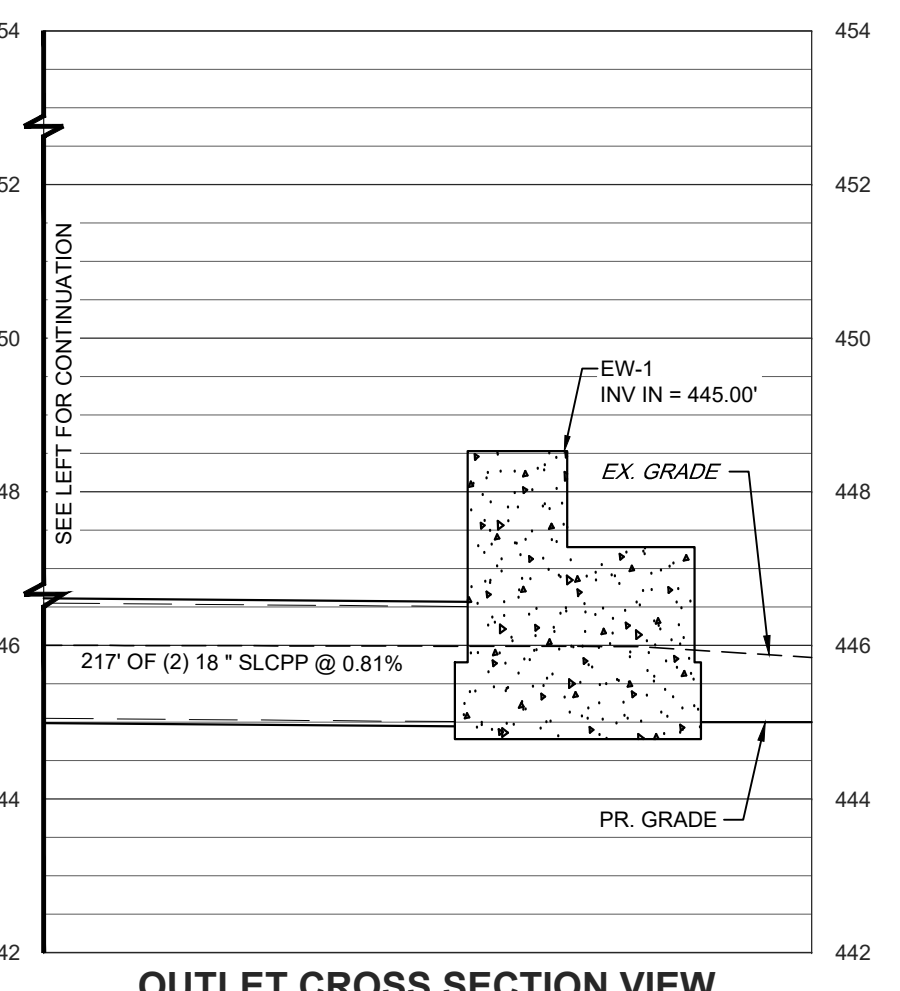


**OUTLET CROSS SECTION VIEW**

REVISION	DATE	BY

**POST CONSTRUCTION STORMWATER MANAGEMENT  
BASIN OUTLET DETAILS**  
**PRELIMINARY/FINAL LAND DEVELOPMENT PLANS**  
for  
**SCOUT COLD LOGISTICS, LLC**  
located in  
NORTH LEBANON TOWNSHIP  
LEBANON County, Pennsylvania

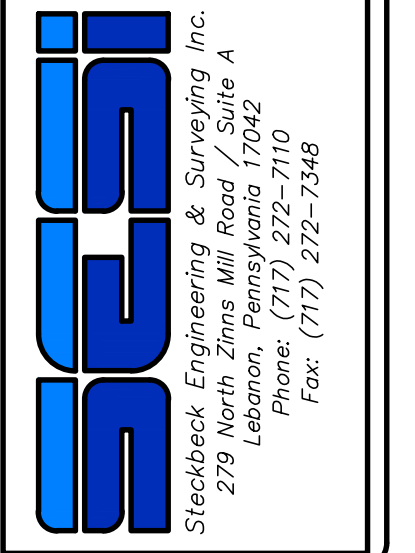

FIELD CREW: MOD, JEC  
BASE MAP: JEC  
DRAWN: CDS  
DESIGN: CDS  
CHECKED: SAS  
DATE: 02/26/24  
SCALE: 1" = 2.5'  
PROJECT # 2368-23-001

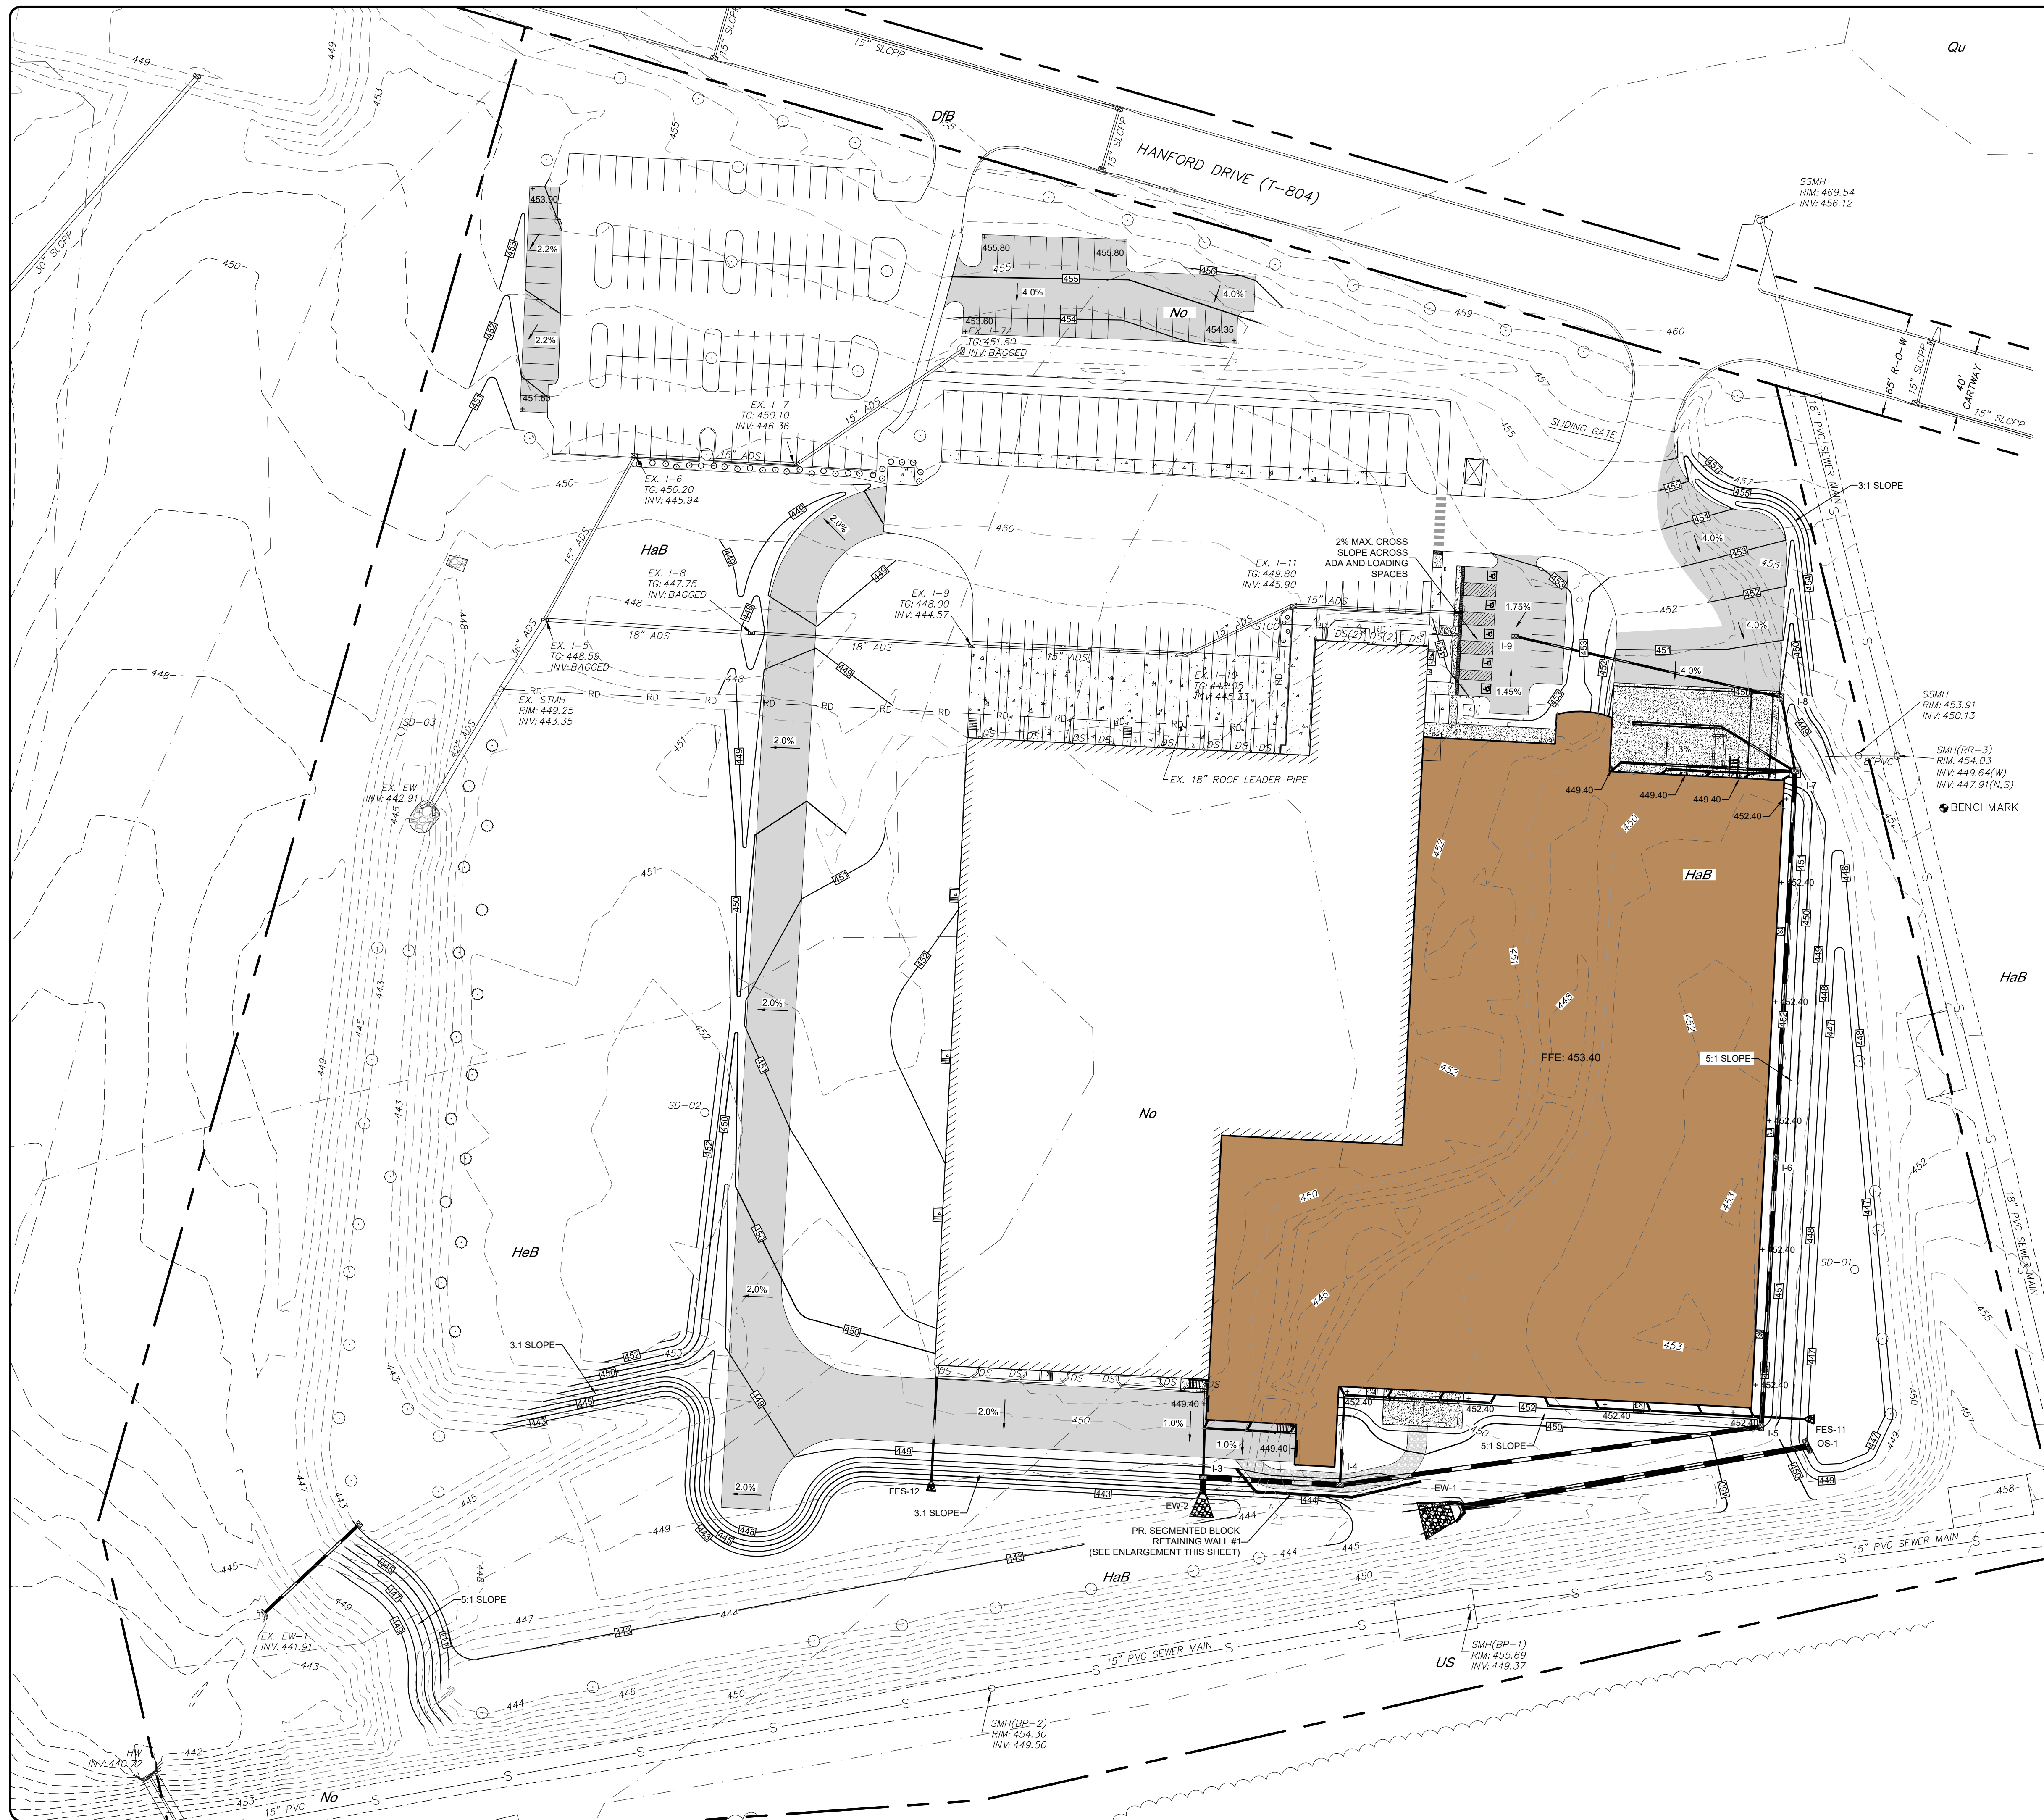


### LEGEND

**EXISTING FEATURES**


- EXISTING ADJOINER LINE
- EXISTING BOUNDARY LINE AND CORNERS
- EXISTING EDGE OF PAVEMENT AND CURB LINE
- EXISTING RIGHT-OF-WAY
- EXISTING FENCE
- EXISTING SEWER
- EXISTING STORMWATER
- EXISTING WATERLINE
- EXISTING GASLINE
- EXISTING SIDEWALK/CONCRETE
- EXISTING CONTOURS
- EXISTING TREELINE
- EXISTING TOWNSHIP BOUNDARY
- LIMITS OF FIELD SURVEY
- EXISTING SOILS
- EXISTING UTILITY POLE
- EXISTING LIGHT POLE
- EXISTING PAVED AREA

**PROPOSED FEATURES**

- PROPOSED BUILDING SETBACK AND CORNERS
- PROPOSED BOUNDARY LINE AND CORNERS
- PROPOSED EDGE OF PAVEMENT AND CURB LINE
- PROPOSED RIGHT-OF-WAY
- PROPOSED FENCE
- PROPOSED SEWER
- PROPOSED STORMWATER
- PR. ELECTRIC SERVICE LINE
- PR. WATER SERVICE LINE
- PROPOSED DOMESTIC WATERLINE
- PROPOSED GASLINE
- PROPOSED CONCRETE/SIDEWALK
- PROPOSED CONTOURS
- PROPOSED TREELINE
- PROPOSED UTILITY POLE
- PROPOSED LIGHT POLE

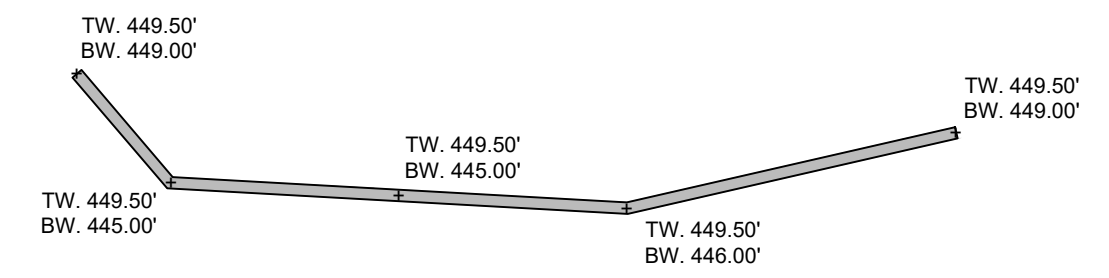

**RETAINING WALL #1 ENLARGEMENT DETAIL**  
NO SCALE

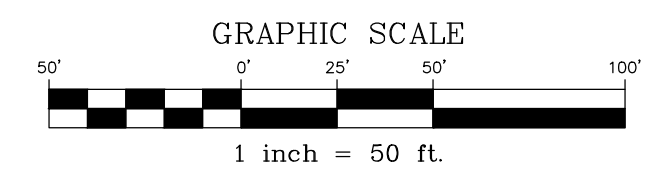

BY	---
DATE	---

REVISION	---
---	---
---	---
---	---

**GRADING PLAN**  
For  
**PRELIMINARY/FINAL LAND DEVELOPMENT PLANS**  
**SCOUT COLD LOGISTICS, LLC**  
located in  
NORTH LEBANON TOWNSHIP  
LEBANON County, Pennsylvania

Steadbeck Engineering & Surveying, Inc.  
279 Lebanon, Pennsylvania 17042  
Phone: (717) 272-7110  
Fax: (717) 272-7348

FIELD CREW:	MOD, JEC
BASE MAP:	JEC
DRAWN:	CDS
DESIGN:	CDS
CHECKED:	SAS
DATE:	02/26/24
SCALE:	1" = 50'
PROJECT #	2368-23-001



### LEGEND


EXISTING FEATURES	
[Symbol]	EXISTING ADJOINER LINE
[Symbol]	EXISTING BOUNDARY LINE AND CORNERS
[Symbol]	EXISTING EDGE OF PAVEMENT AND CURB LINE
[Symbol]	EXISTING RIGHT-OF-WAY
[Symbol]	EXISTING FENCE
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[Symbol]	EXISTING STORMWATER
[Symbol]	EXISTING WATERLINE
[Symbol]	EXISTING GASLINE
[Symbol]	EXISTING SIDEWALK/CONCRETE
[Symbol]	EXISTING CONTOURS
[Symbol]	EXISTING TREELINE
[Symbol]	EXISTING TOWNSHIP BOUNDARY
[Symbol]	LIMITS OF FIELD SURVEY
[Symbol]	EXISTING SOILS
[Symbol]	EXISTING UTILITY POLE
[Symbol]	EXISTING LIGHT POLE
[Symbol]	EXISTING PAVED AREA

PROPOSED FEATURES	
[Symbol]	PROPOSED BUILDING SETBACK
[Symbol]	PROPOSED BOUNDARY LINE AND CORNERS
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[Symbol]	PROPOSED RIGHT-OF-WAY
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[Symbol]	PR. ELECTRIC SERVICE LINE
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[Symbol]	PROPOSED GASLINE
[Symbol]	PROPOSED CONCRETE/SIDEWALK
[Symbol]	PROPOSED CONTOURS
[Symbol]	PROPOSED TREELINE
[Symbol]	PROPOSED UTILITY POLE
[Symbol]	PROPOSED LIGHT POLE

**GREASE TRAP NOTE**  
 OWNER SHALL PROVIDE GREASE TRAP AT LOCATION INDICATED ON UTILITY PLAN. OWNER SHALL SUBMIT CATALOG CUTS, SHOP DRAWINGS AND ANY OTHER PRODUCT DATA AS REQUESTED BY NLMA TO DESCRIBE PROPOSED UNIT PRIOR TO MAKING APPLICATION TO NLMA FOR SEWER PERMIT. IN ADDITION, OWNER SHALL SUBMIT DETAILED SIZING CALCULATIONS PREPARED BY MANUFACTURER OF PROPOSED UNIT BASED ON PROJECTED FLOWS AND WASTE STREAM CHARACTERISTICS FOR NLMA REVIEW.


- UTILITY NOTES**
- SEWAGE DISPOSAL IS TO BE PROVIDED BY EXTENSION OF THE PUBLIC SEWER SYSTEM BY THE LAND DEVELOPER, AS SHOWN HEREON. CONNECTION TO THE NORTH LEBANON TOWNSHIP MUNICIPAL AUTHORITY PUBLIC SEWER SYSTEM IS REQUIRED.
  - ALL SANITARY SEWER CONSTRUCTION METHODS AND MATERIALS SHALL CONFORM TO THE LATEST STANDARDS OF THE NORTH LEBANON TOWNSHIP MUNICIPAL AUTHORITY AND SHALL BE SUBJECT TO APPROVAL BY THE AUTHORITY'S ENGINEER.
  - WATER AND SEWER LINES MUST MAINTAIN A MINIMUM HORIZONTAL SEPARATION OF 5'. OTHERWISE A VERTICAL SEPARATION OF 18" SHALL BE PROVIDED. IF NEITHER IS POSSIBLE, THEN A 6" CONCRETE ENCASUREMENT SHALL BE PROVIDED FOR THE SEWER LINE.
  - ALL UTILITIES SHALL BE INSTALLED UNDERGROUND INCLUDING BUT NOT LIMITED TO TELEPHONE, CABLE, ELECTRIC, GAS, WATER AND SANITARY SEWER.
  - ACCESS TO ALL UTILITY FACILITIES SHALL BE GRANTED TO REPRESENTATIVES OF NORTH LEBANON TOWNSHIP MUNICIPAL AUTHORITY AND THE CITY OF LEBANON AUTHORITY AT ALL TIMES FOR THE PURPOSES OF INSPECTION AND MAINTENANCE.
  - CONSTRUCTION OF SEWER LATERALS SHALL COMPLY WITH THE RULES, REGULATIONS, AND SPECIFICATIONS OF THE NORTH LEBANON TOWNSHIP MUNICIPAL AUTHORITY. DO NOT BACKFILL SEWER LATERAL TRENCHES UNTIL INSPECTED BY A REPRESENTATIVE OF THE AUTHORITY.
  - CONSTRUCTION OF WATER LATERALS SHALL COMPLY WITH THE RULES, REGULATIONS, AND SPECIFICATIONS OF THE CITY OF LEBANON WATER AUTHORITY.

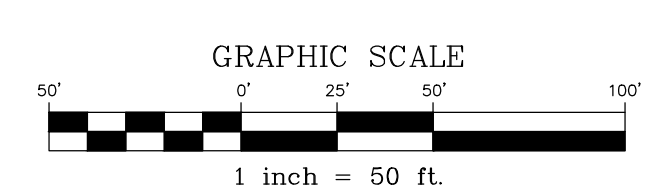

BY	
DATE	


REVISION	

UTILITY PLAN  
 For  
**PRELIMINARY/FINAL LAND DEVELOPMENT PLANS**  
**SCOUT COLD LOGISTICS, LLC**  
 located in  
 NORTH LEBANON TOWNSHIP  
 LEBANON County, Pennsylvania

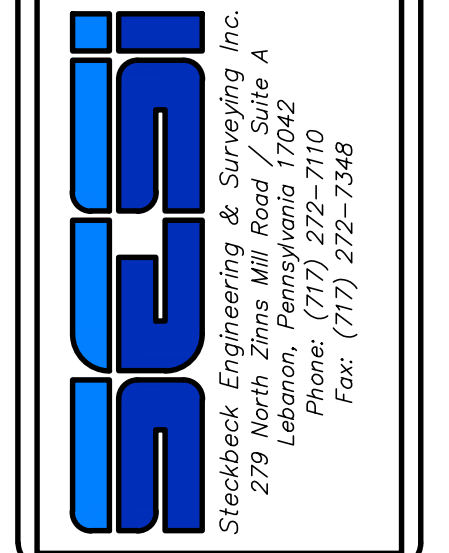


FIELD CREW:	MOD,JEC
BASE MAP:	JEC
DRAWN:	CDS
DESIGN:	CDS
CHECKED:	SAS
DATE:	02/26/24
SCALE:	1" = 50'
PROJECT #	2368-23-001

KEY	QTY	SIZE	BOTANICAL NAME	COMMON NAME
GB	4	2' CAL.	GINKGO BILOBA 'AUTUMN GOLD'	AUTUMN GOLD MAIDENHAIR TREE
ZS	7	2' CAL.	ZELKOVA SERRATA 'GREEN VASE'	GREEN VASE ZELKOVA
AR	4	2'-2.5' CAL.	ACER RUBRUM 'OCTOBER GLORY'	RED MAPLE
GR	3	2'-2.5' CAL.	CERCIS CANADENSIS 'HEARTS OF GOLD'	HEARTS OF GOLD REDBUD
PM	8	6'	PICEA PUNGENS 'MOERHEIM'	MOERHEIM BLUE SPRUCE
PS	7	6'	PINUS STROBUS	EASTERN WHITE PINE

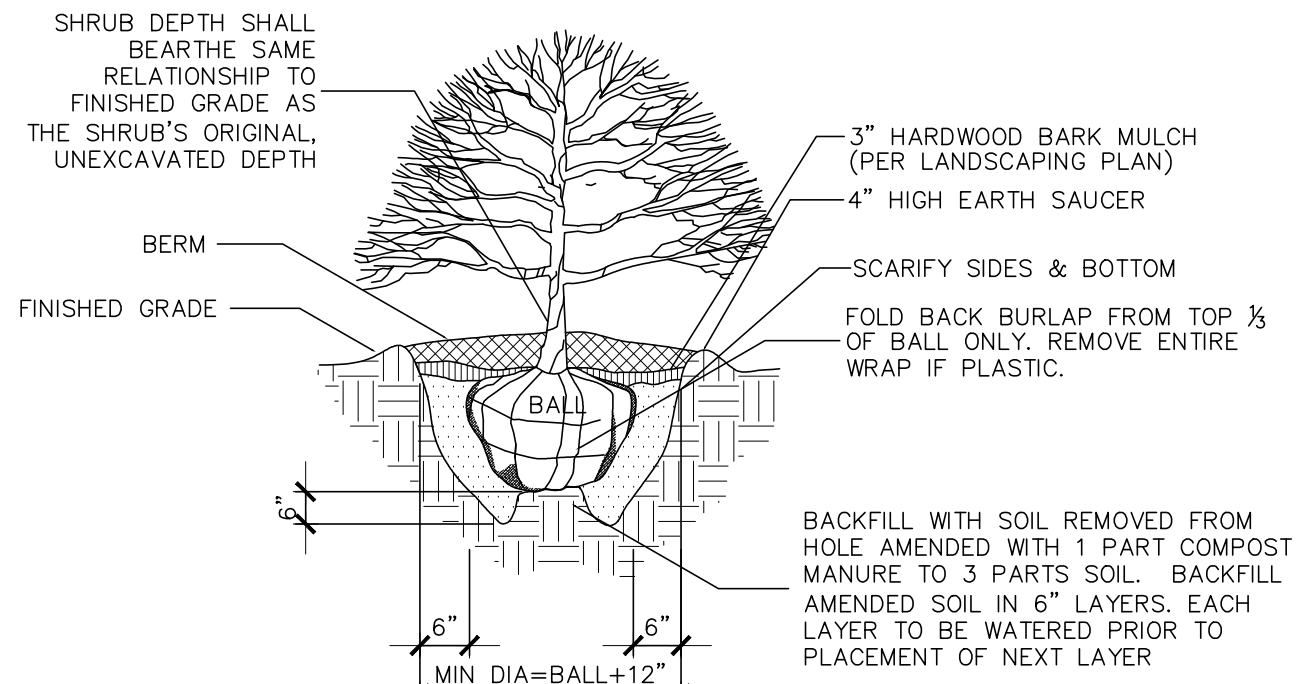


**SHRUB PLANTING DETAIL**

NO SCALE

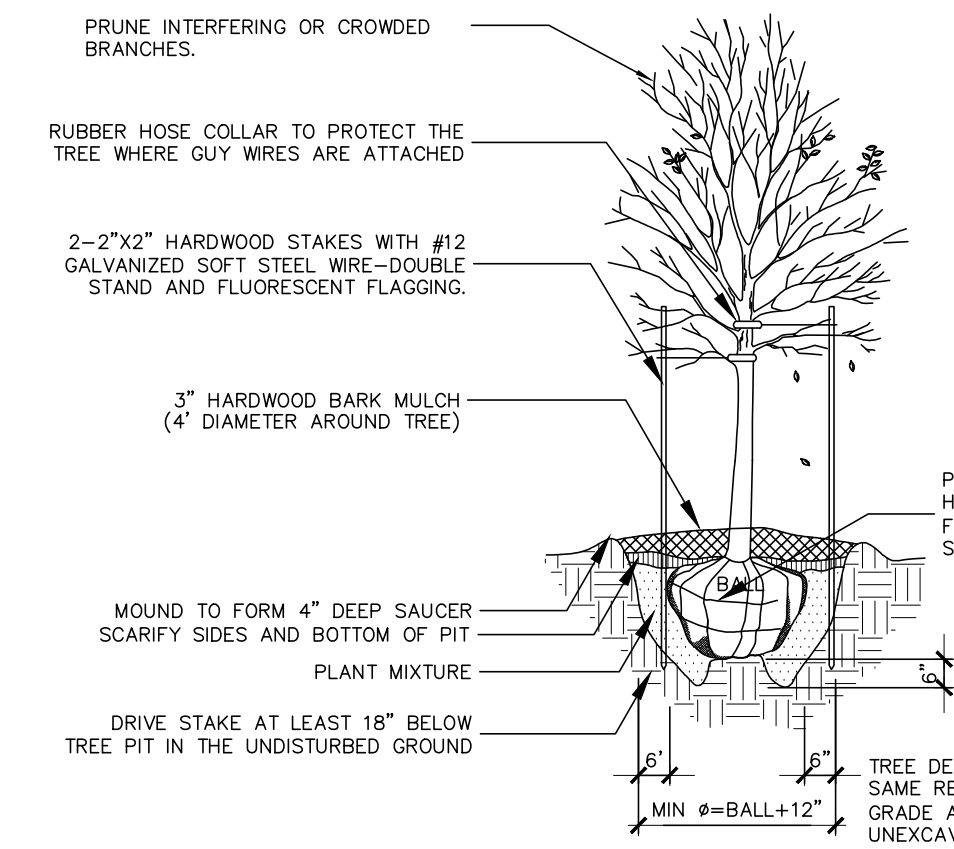

**DECIDUOUS TREE PLANTING DETAIL**

NO SCALE

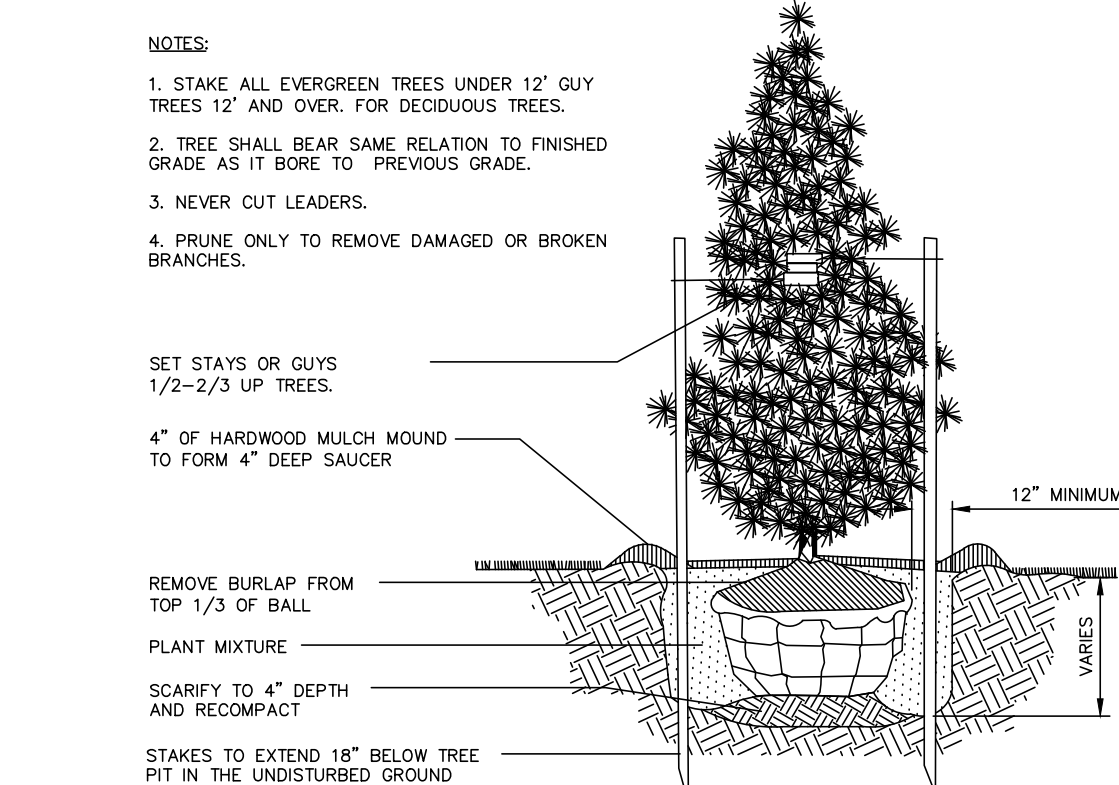

**EVERGREEN TREE PLANTING DETAIL**

NO SCALE

**GENERAL LANDSCAPE NOTES (BY LANDSCAPE CONTRACTOR)**

1. THE CONTRACTOR SHALL DETERMINE THE LOCATION OF ALL UTILITIES AND SHALL ASSUME RESPONSIBILITY FOR DAMAGE TO UTILITIES AND PROPERTY AS A RESULT OF HIS WORK.
2. ALL PLANT MATERIAL IS TO BE GUARANTEED FOR A PERIOD OF EIGHTEEN (18) MONTHS FROM THE DATE OF INSTALLATION AND ACCEPTANCE BY OWNER.
3. PLANT MATERIAL SHALL BE TRUE TO SPECIES AND VARIETY AND SHALL CONFORM TO MEASUREMENTS AND MINIMUM STANDARDS AS SET FORTH IN THE PLANT SCHEDULE.
4. ALL PLANTING BEDS ARE TO BE MULCHED WITH A MINIMUM OF 3" OF SHREDDED AGED HARDWOOD BARK MULCH.
5. THE CONTRACTOR IS TO PROVIDE ADDITIONAL TOPSOIL AS NEEDED FOR PLANTING OPERATIONS.
6. ALL TREES ARE TO BE STAKED AND GUYED ACCORDING TO THE PLANTING DETAILS AND ACCEPTED PROFESSIONAL NURSERYMAN'S STANDARDS. TREES WITH LESS THAN A 3" CALIPER SHALL BE PROPERLY STAKED AND MORE THAN A 3" CALIPER PROPERLY GUYED. ALL PLANTING DETAILS ARE LOCATED ON THE LANDSCAPING PLAN (SHEETS 12 & 13). ALL STREET TREES MUST BE A MINIMUM OF 2.50 INCHES IN DIAMETER.
7. THE CONTRACTOR SHALL REMOVE WIRE BASKETS AND NYLON BURLAP OR ROPE FROM THE ROOT BALL OF ALL PLANT MATERIAL.
8. APPLY A 50/50 MIX OF CHIPCO RONSTAR 6 AND PENNANT 56 TO SOIL SURFACE IN MULCHED AREAS PRIOR TO MULCHING. APPLY AT A RATE OF 7 POUNDS PER 1000 SF.
9. PLACE "WEED BLOCK" WATER PERMEABLE FILTRATION FABRIC UNDER MULCHED AREAS EXCEPT FOR AREAS OF GROUND COVER (I.E. IVY AND VINCA) AND PERENNIAL BEDS.
10. LANDSCAPE CONTRACTOR SHALL COORDINATE HIS/HER WORK WITH ALL OTHER CONTRACTORS ON SITE.
11. ALL AREAS OTHER THAN PLANTING BED AREAS SHALL BE CONSIDERED LAWN AREAS.
12. THE LANDSCAPE CONTRACTOR SHALL BE RESPONSIBLE TO CLEAN AND REMOVE/DISPOSE FROM THE SITE ALL DEBRIS THAT IS A PART OF THE LANDSCAPE CONTRACTOR'S OPERATION.
13. THE CONTRACTOR SHALL INSTALL ORANGE PLASTIC CONSTRUCTION FENCE AROUND EXISTING MATURE TREES TO PREVENT ROOT ZONE COMPACTION AND DAMAGE TO TRUNKS AND BRANCHES. THE FENCING SHALL BE INSTALLED TO PREVENT DAMAGE AT A MINIMUM OF 2/3 OF THE DIAMETER OF THE TREE CANOPY.

**LANDSCAPING LONG-TERM MAINTENANCE NOTES:**

1. A QUALIFIED LANDSCAPE CONTRACTOR KNOWLEDGEABLE IN PRUNING TECHNIQUES, FERTILIZER APPLICATION, PEST CONTROL, AND LAWN CARE SHALL PERFORM ANNUAL LANDSCAPE MAINTENANCE.
2. THE INDIVIDUAL HOMEOWNERS SHALL BE RESPONSIBLE FOR REGULAR MOWING OF ALL PRIVATE LAWN AREAS. THE HOME OWNERS ASSOCIATION SHALL BE RESPONSIBLE FOR REGULAR MOWING OF ALL COMMON AREAS.
3. ANY PLANT MATERIAL SHOWN ON THE APPROVED LANDSCAPE PLAN THAT DOES NOT SURVIVE OR IS DAMAGED SHALL BE REPLACED IN KIND BY THE OWNER WITHIN A SIX-MONTH PERIOD.


**SHORT-TERM MAINTENANCE**

1. THE CONTRACTOR SHALL BE RESPONSIBLE FOR WATERING PLANT MATERIAL AND LAWN AREAS BEFORE, DURING, AND AFTER INSTALLATION UNTIL ACCEPTANCE OF PLANTINGS BY THE OWNER.
2. NEW LAWN AREAS SHALL BE MAINTAINED BY THE LANDSCAPE CONTRACTOR UNTIL FINAL ACCEPTANCE.
3. NEWLY INSTALLED PLANTINGS SHALL BE SELECTIVELY PRUNED, IF NECESSARY TO PROVIDE A NEAT AND UNIFORM APPEARANCE. ANY DEAD OR BROKEN BRANCHES SHALL BE REMOVED. ALL NOTICEABLY DISEASED OR DAMAGED PLANT MATERIAL SHALL BE REMOVED AND REPLACED PRIOR TO FINAL ACCEPTANCE.
4. LAWN AREAS SHALL BE WATERED ONCE WEEKLY DURING DRY PERIODS OF THE FIRST GROWING SEASON TO ESTABLISH A HEALTHY TURFGRASS. WATERING SHOULD OCCUR DURING THE EARLY PART OF THE DAY TO AN EVEN SATURATION DEPTH OF ONE (1) INCH.
5. ALL GUYING AND STAKING SHALL BE MAINTAINED REGULARLY TO ASSUME PLANT STABILIZATION AND STRAIGHT, UNIFORM GROWTH FOR AT LEAST THE FIRST YEAR FOLLOWING THE DATE OF PLANTING.
6. NEWLY PLANTED TREES AND SHRUBS SHALL BE WATERED REGULARLY DURING ANY DRY PERIODS TO COMPLETELY SATURATE THE ROOT BALL DURING THE FIRST GROWING SEASON.
7. ALL PLANT MATERIAL SHALL BE TRUE TO SPECIES AND VARIETY AND SHALL CONFORM TO MEASUREMENTS AND MINIMUM STANDARDS AS SET FORTH IN THE PLANT SCHEDULE.
8. DISEASE, INSECT AND WEED CONTROL AND PREVENTION SHOULD BE PERFORMED IN ACCORDANCE WITH MANUFACTURER RECOMMENDATIONS FOR NEWLY PLANTED LANDSCAPES DURING THE FIRST SEASON.
9. ALL PLANT MATERIAL IS TO BE GUARANTEED FOR A PERIOD OF ONE (1) YEAR FROM THE DATE OF INSTALLATION AND ACCEPTANCE BY THE OWNER.





**LEGEND**

**EXISTING FEATURES**

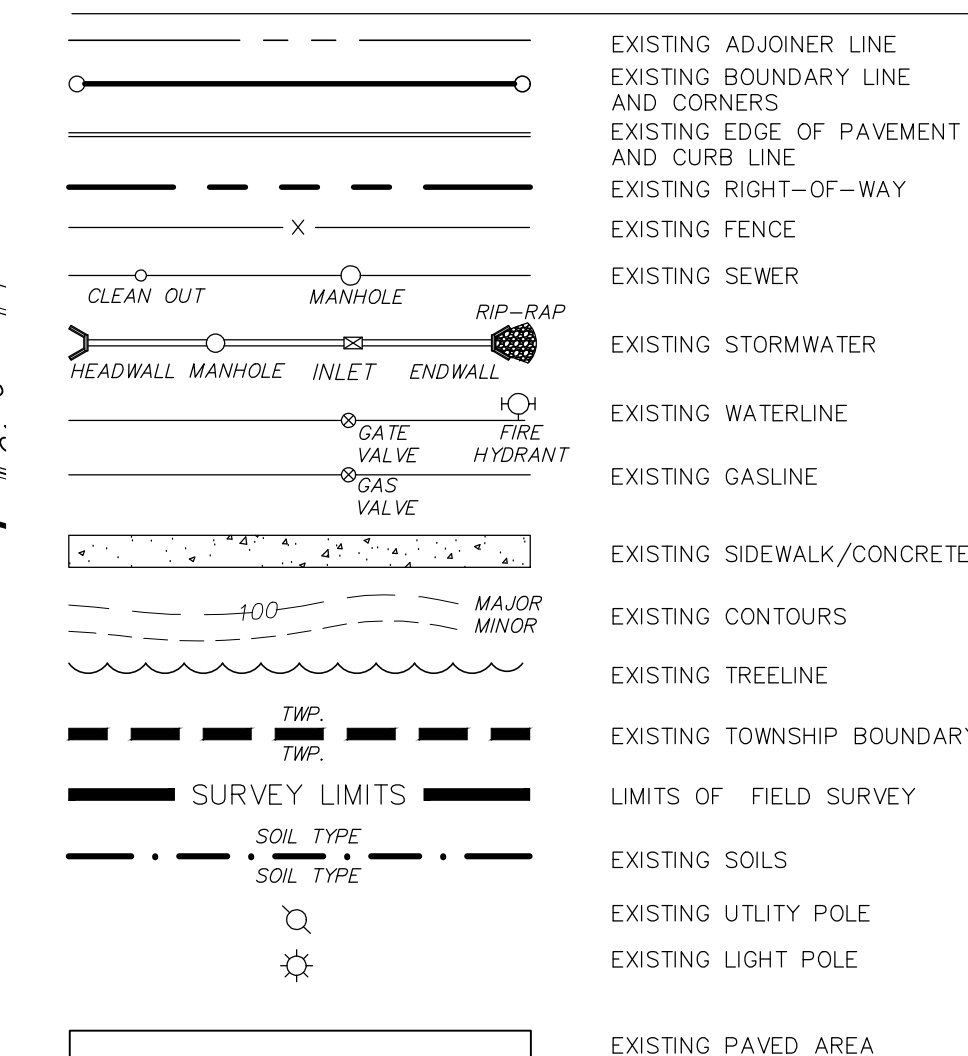

**PROPOSED FEATURES**

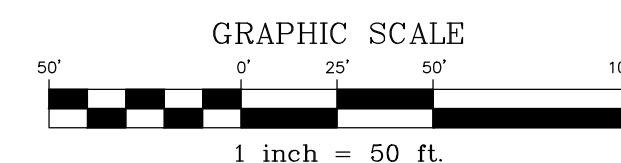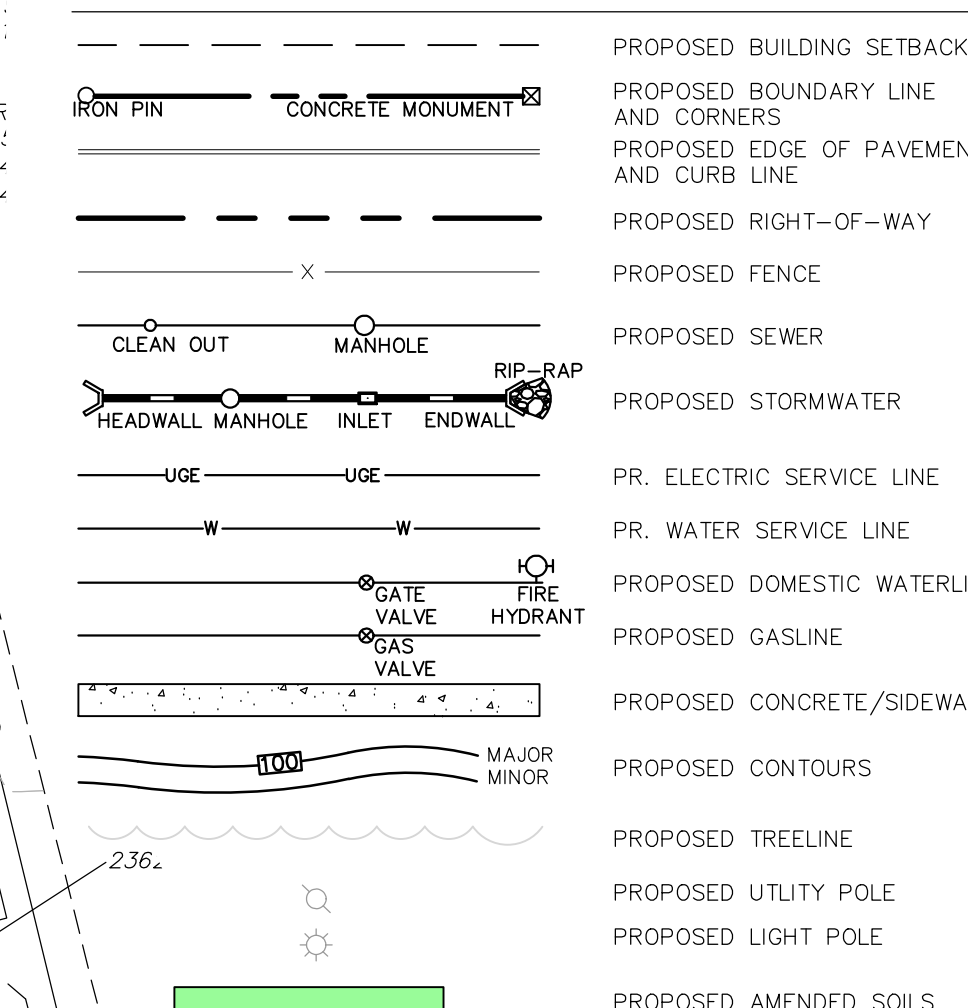


BY	DATE	REVISION

**LANDSCAPING PLAN**  
**PRELIMINARY/FINAL LAND DEVELOPMENT PLANS**  
 For  
**SCOUT COLD LOGISTICS, LLC**  
 located in  
 NORTH LEBANON TOWNSHIP  
 LEBANON County, Pennsylvania

**RES**  
 Steckbeck Engineering & Surveying, Inc.  
 279 Lebanon, Pennsylvania 17042  
 Phone: (717) 272-7110  
 Fax: (717) 272-7348

FIELD CREW: MOD,JEC  
 BASE MAP: JEC  
 DRAWN: CDS  
 DESIGN: CDS  
 CHECKED: SAS  
 DATE: 02/26/24  
 SCALE: 1" = 50'  
 PROJECT # 2368-23-001

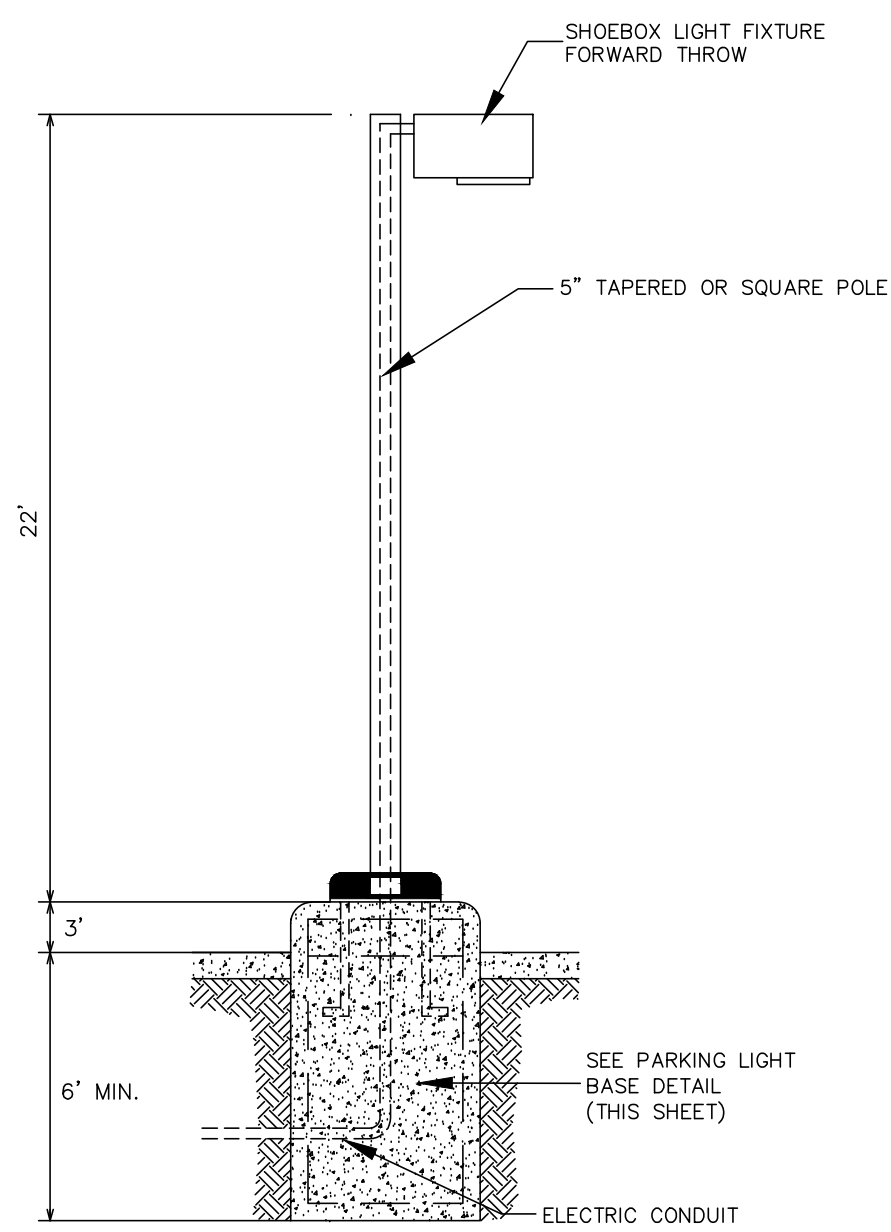


Installation/Mounting In Accordance With Light Standards Manufacturers Specifications.

NOTE: This detail is a typical detail only. Site conditions and/or pole/fixture type may vary. Consult with pole/fixture manufacturer for foundation requirements.


**TYPICAL 20' POLE & FOUNDATION**

NO SCALE

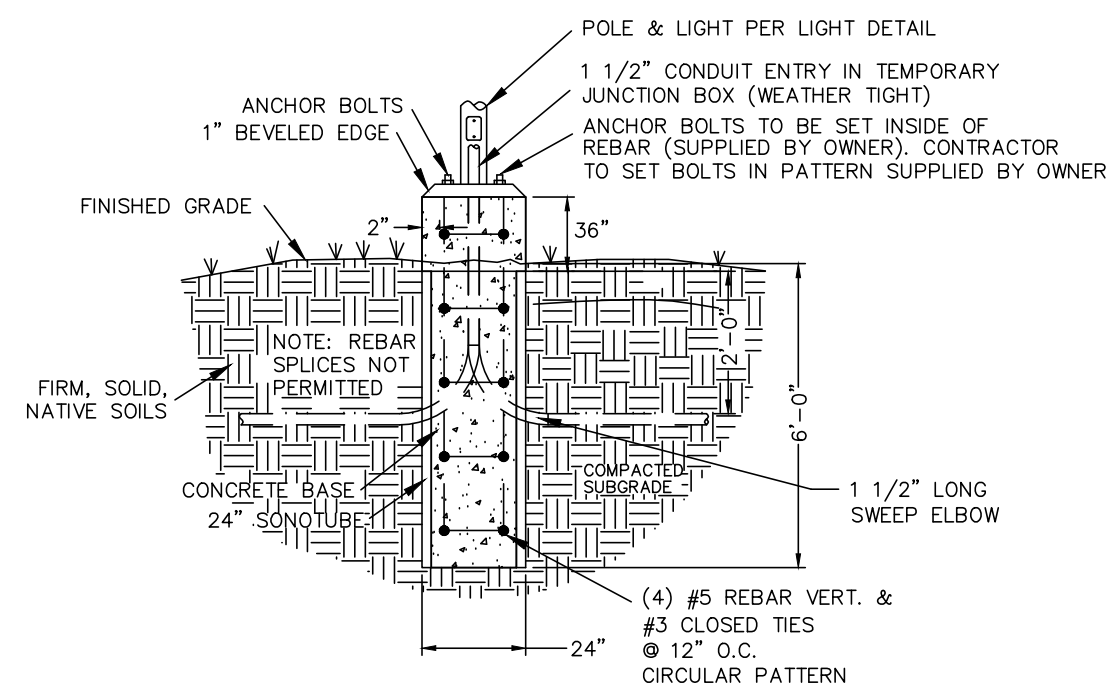

**PARKING LIGHT BASE DETAIL**

NO SCALE

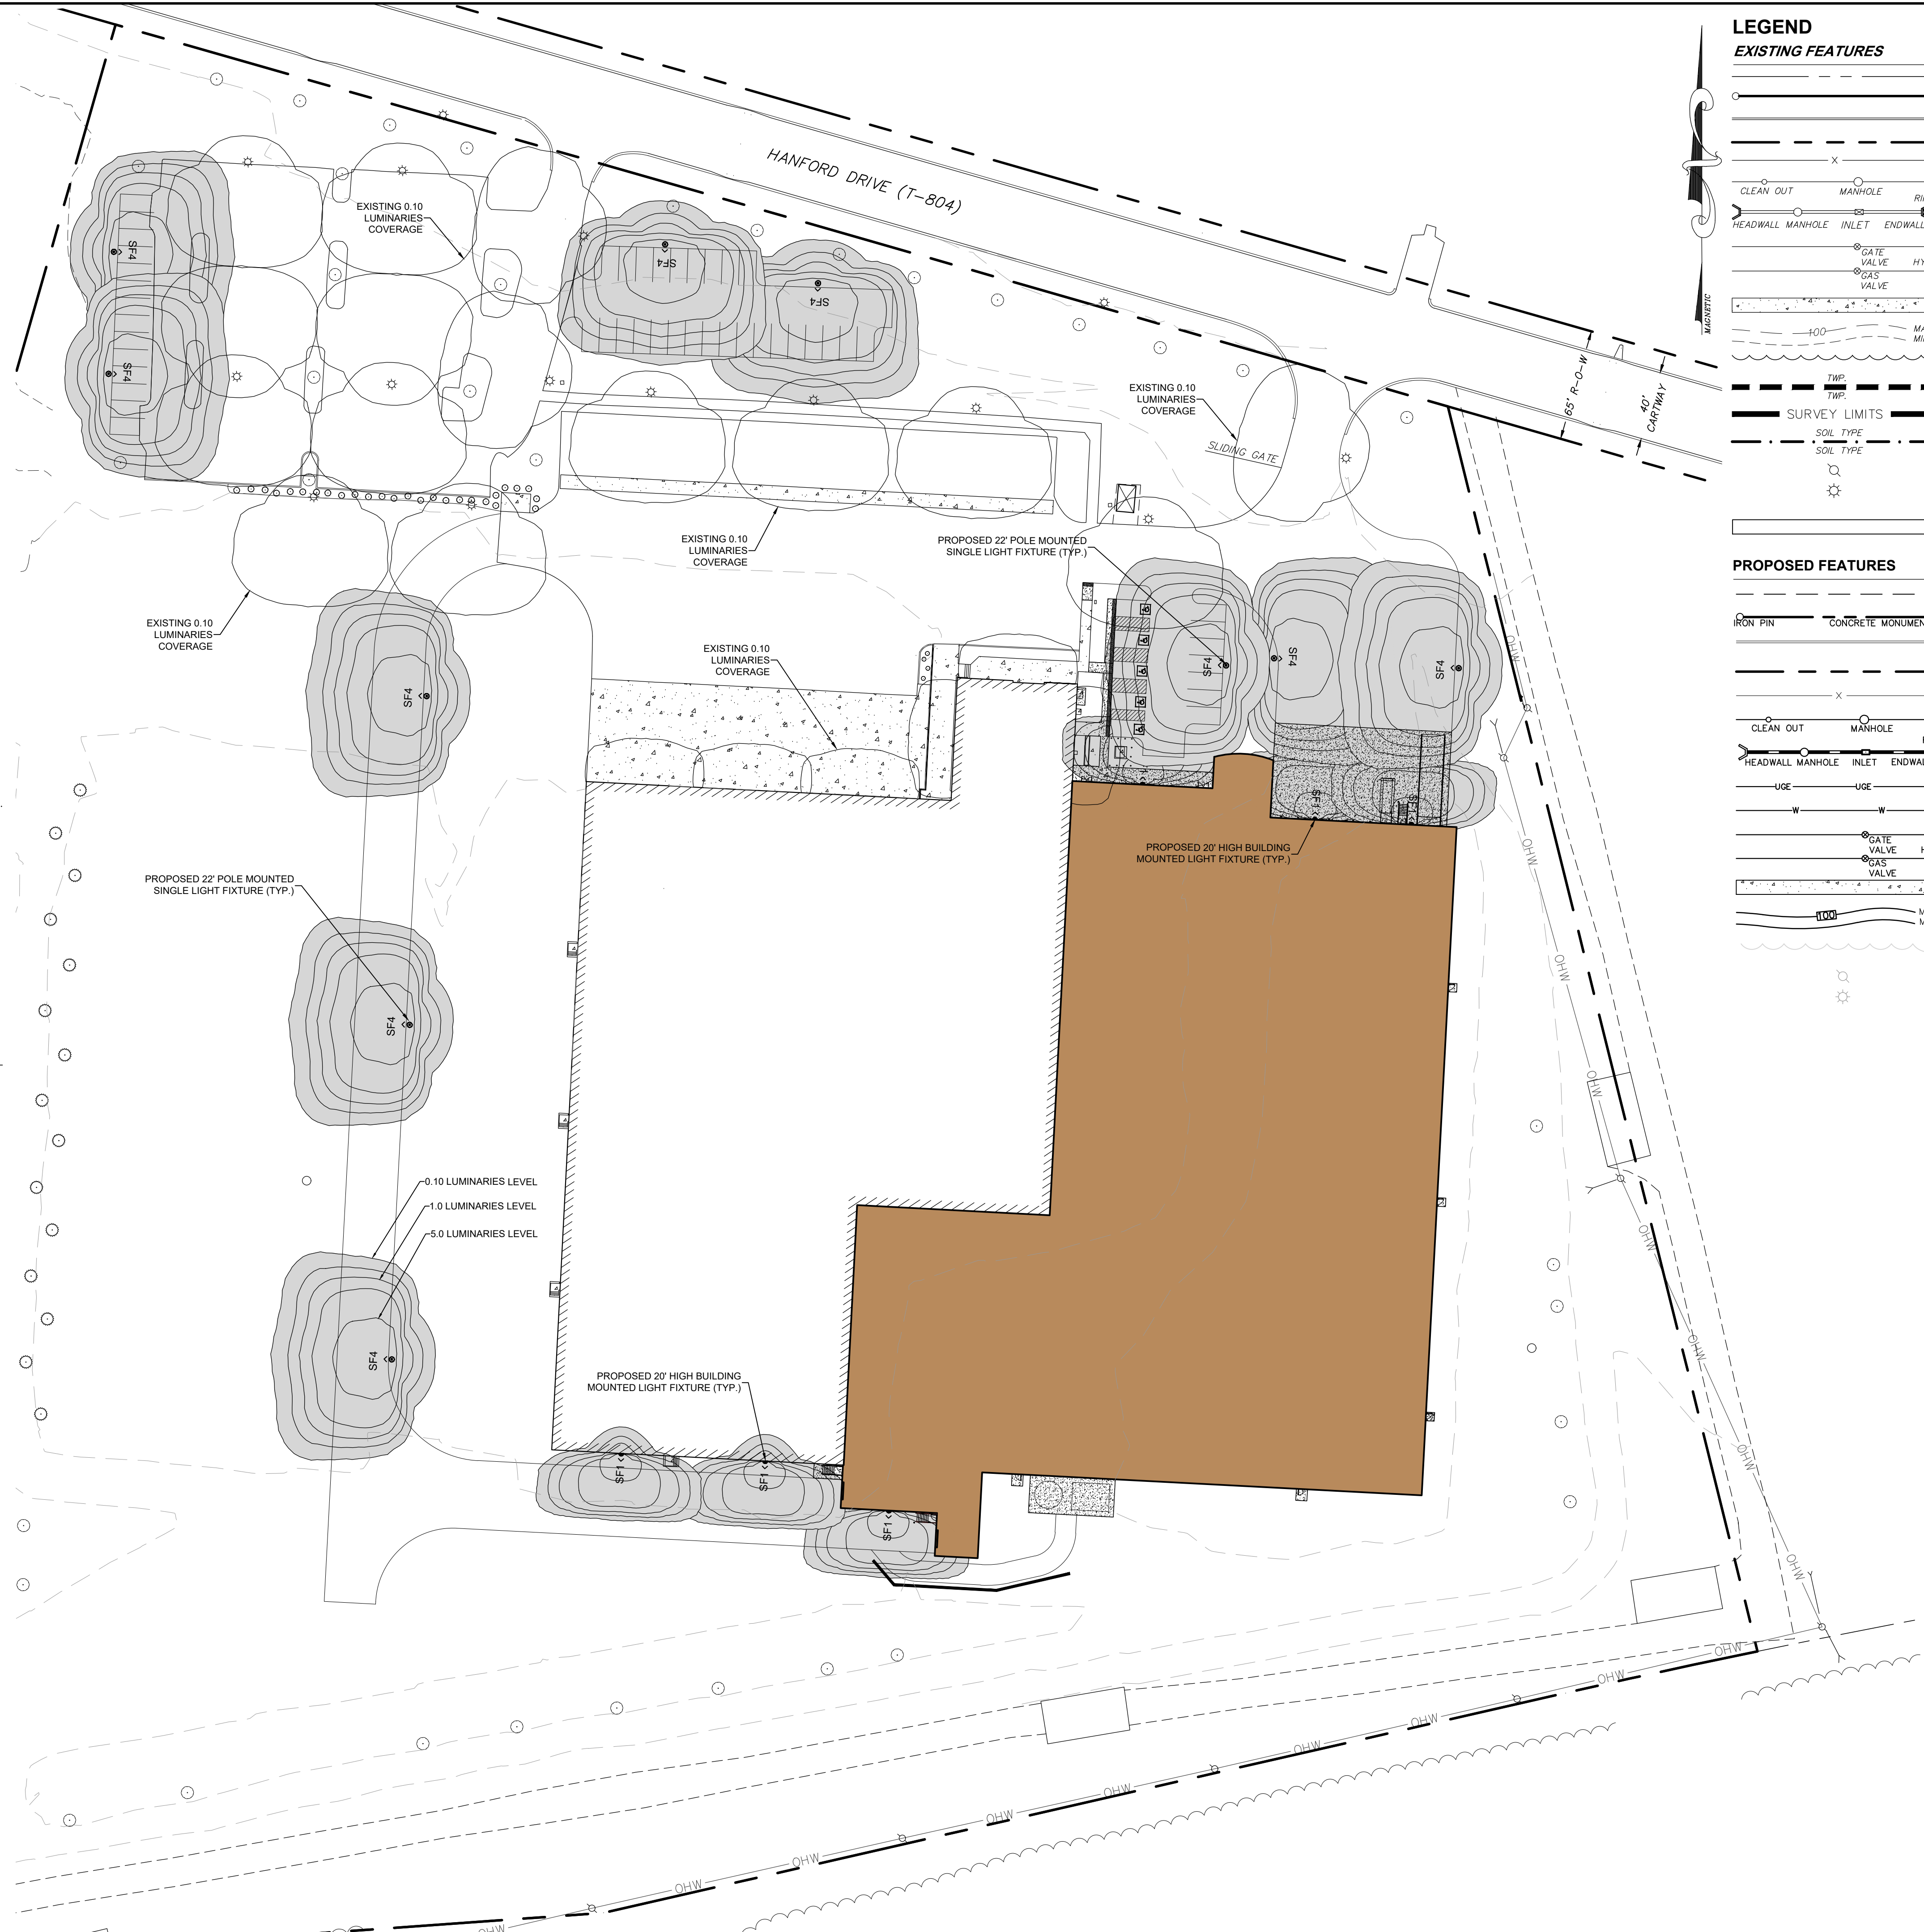


**LEGEND**  
**EXISTING FEATURES**

- EXISTING ADJOINER LINE
- EXISTING BOUNDARY LINE AND CORNERS
- EXISTING EDGE OF PAVEMENT AND CURB LINE
- EXISTING RIGHT-OF-WAY
- EXISTING FENCE
- EXISTING SEWER
- EXISTING STORMWATER
- EXISTING WATERLINE
- EXISTING GASLINE
- EXISTING SIDEWALK/CONCRETE
- EXISTING CONTOURS
- EXISTING TREELINE
- EXISTING TOWNSHIP BOUNDARY
- LIMITS OF FIELD SURVEY
- EXISTING SOILS
- EXISTING UTILITY POLE
- EXISTING LIGHT POLE
- EXISTING PAVED AREA

**PROPOSED FEATURES**

- PROPOSED BUILDING SETBACK
- PROPOSED BOUNDARY LINE AND CORNERS
- PROPOSED EDGE OF PAVEMENT AND CURB LINE
- PROPOSED RIGHT-OF-WAY
- PROPOSED FENCE
- PROPOSED SEWER
- PROPOSED STORMWATER
- PR. ELECTRIC SERVICE LINE
- PR. WATER SERVICE LINE
- PROPOSED DOMESTIC WATERLINE
- PROPOSED GASLINE
- PROPOSED CONCRETE/SIDEWALK
- PROPOSED CONTOURS
- PROPOSED TREELINE
- PROPOSED UTILITY POLE
- PROPOSED LIGHT POLE





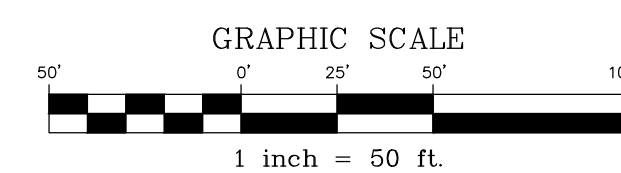


BY	---
DATE	---
REVISION	---

REVISION	---
DATE	---
BY	---

**LIGHTING PLAN**  
For  
**PRELIMINARY/FINAL LAND DEVELOPMENT PLANS**  
**SCOUT COLD LOGISTICS, LLC**  
located in  
NORTH LEBANON TOWNSHIP  
LEBANON County, Pennsylvania

FIELD CREW:	MOD, JEC
BASE MAP:	JEC
DRAWN:	CDS
DESIGN:	CDS
CHECKED:	SAS
DATE:	02/26/24
SCALE:	1" = 50'
PROJECT #	2368-23-001

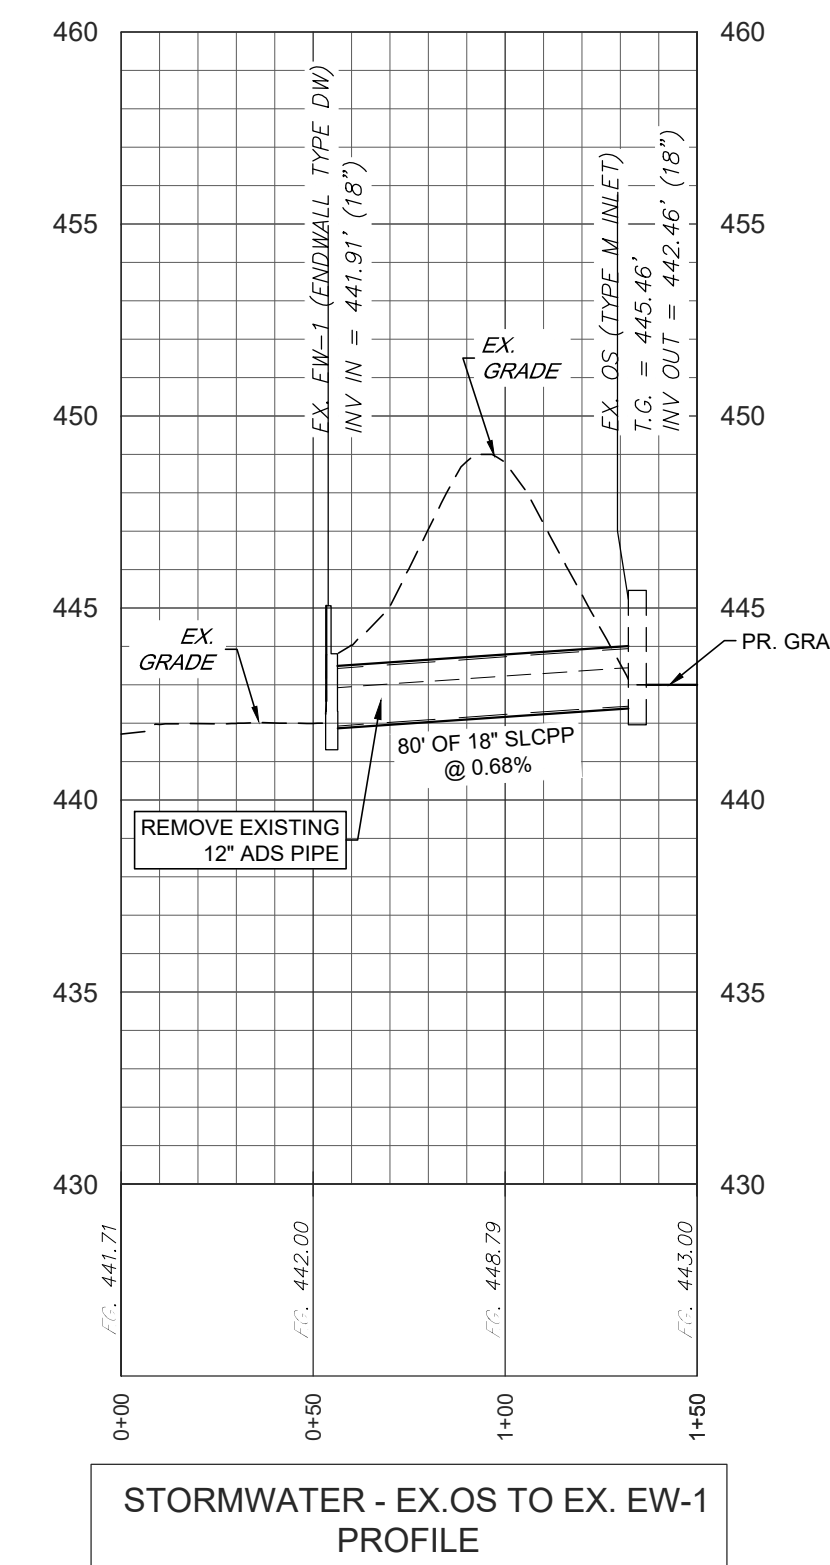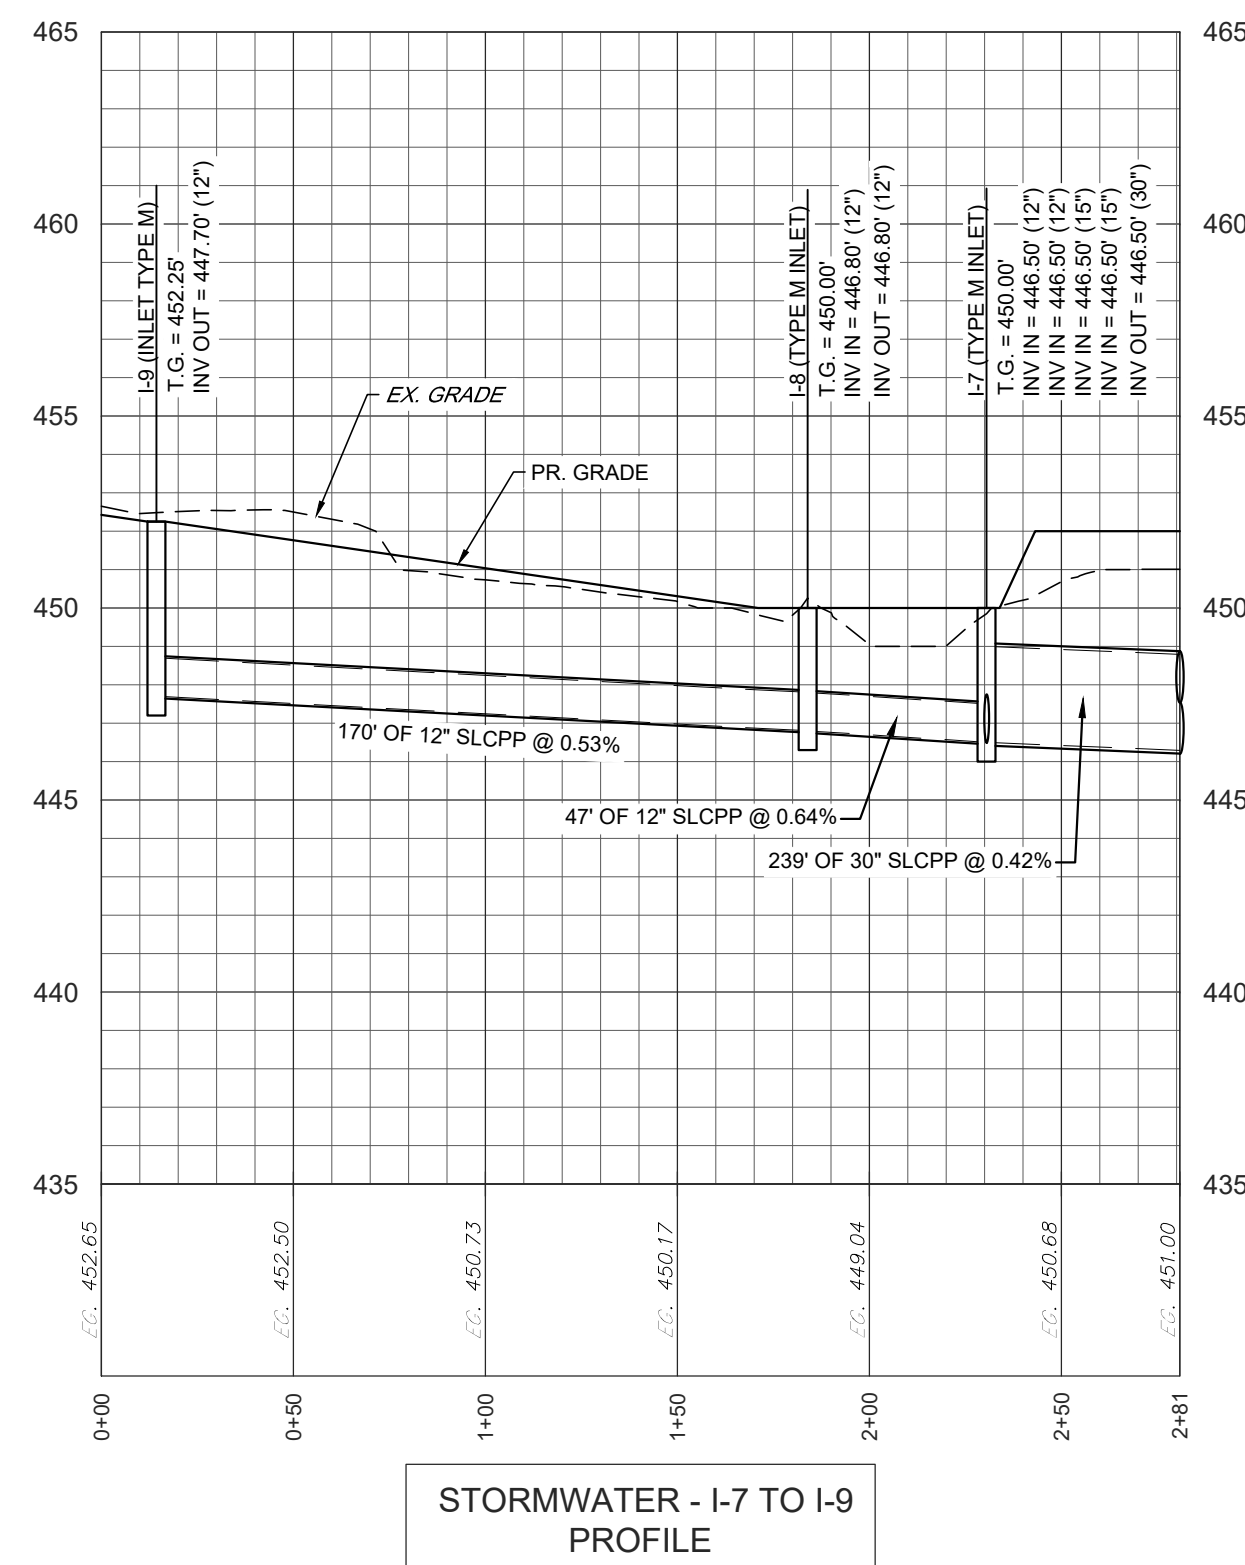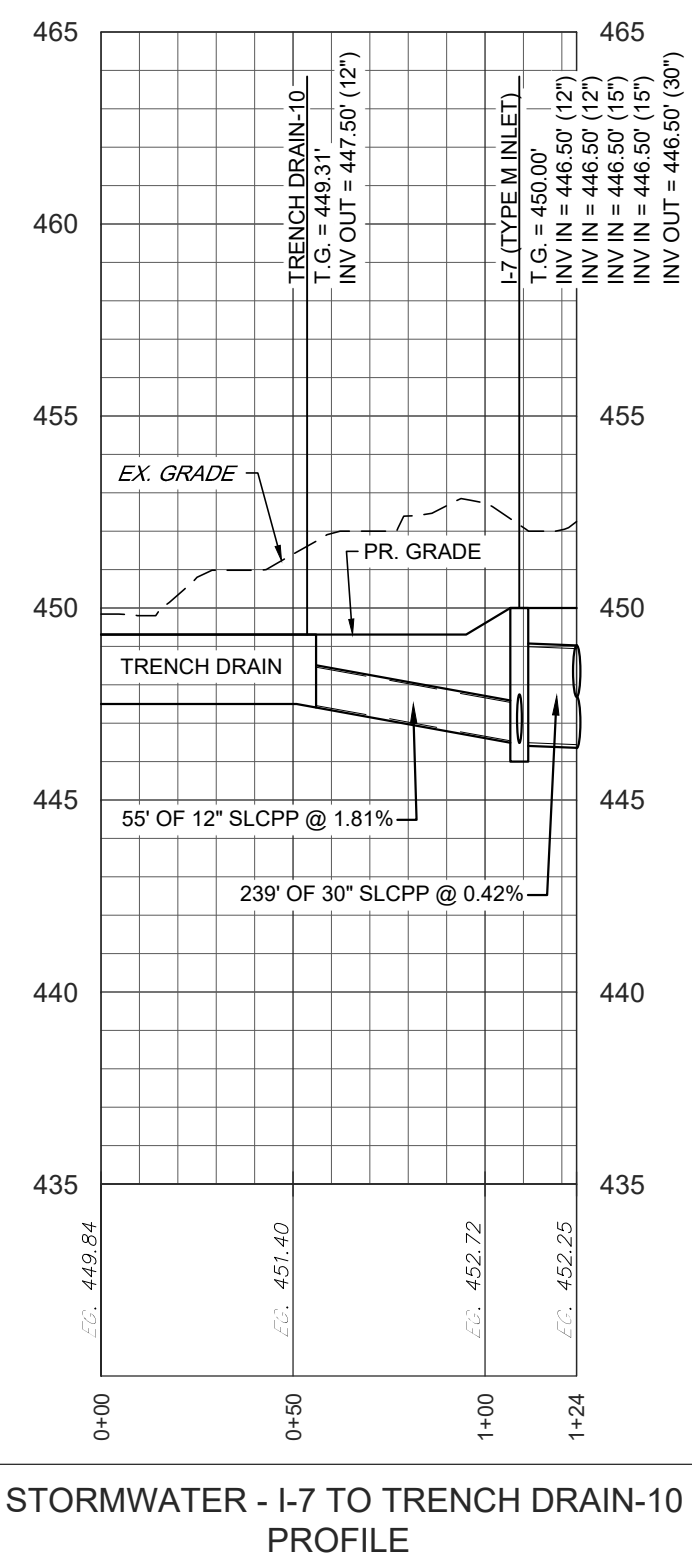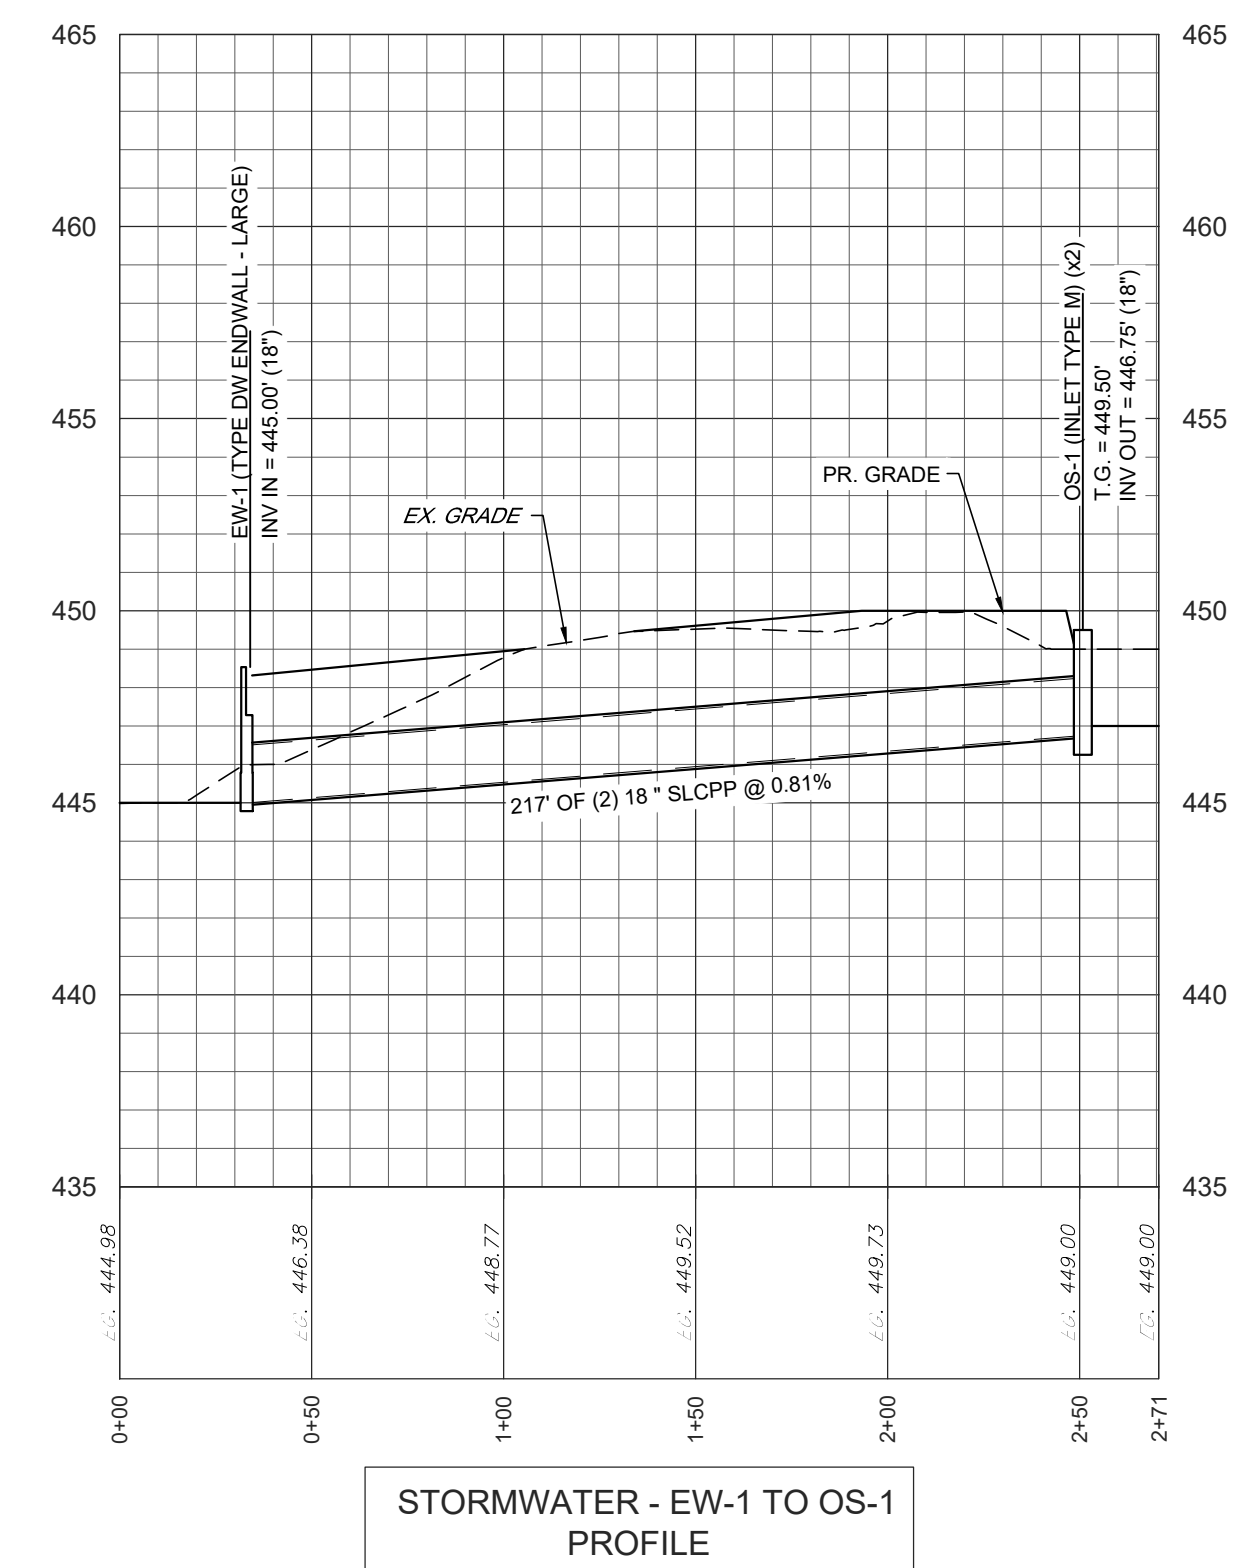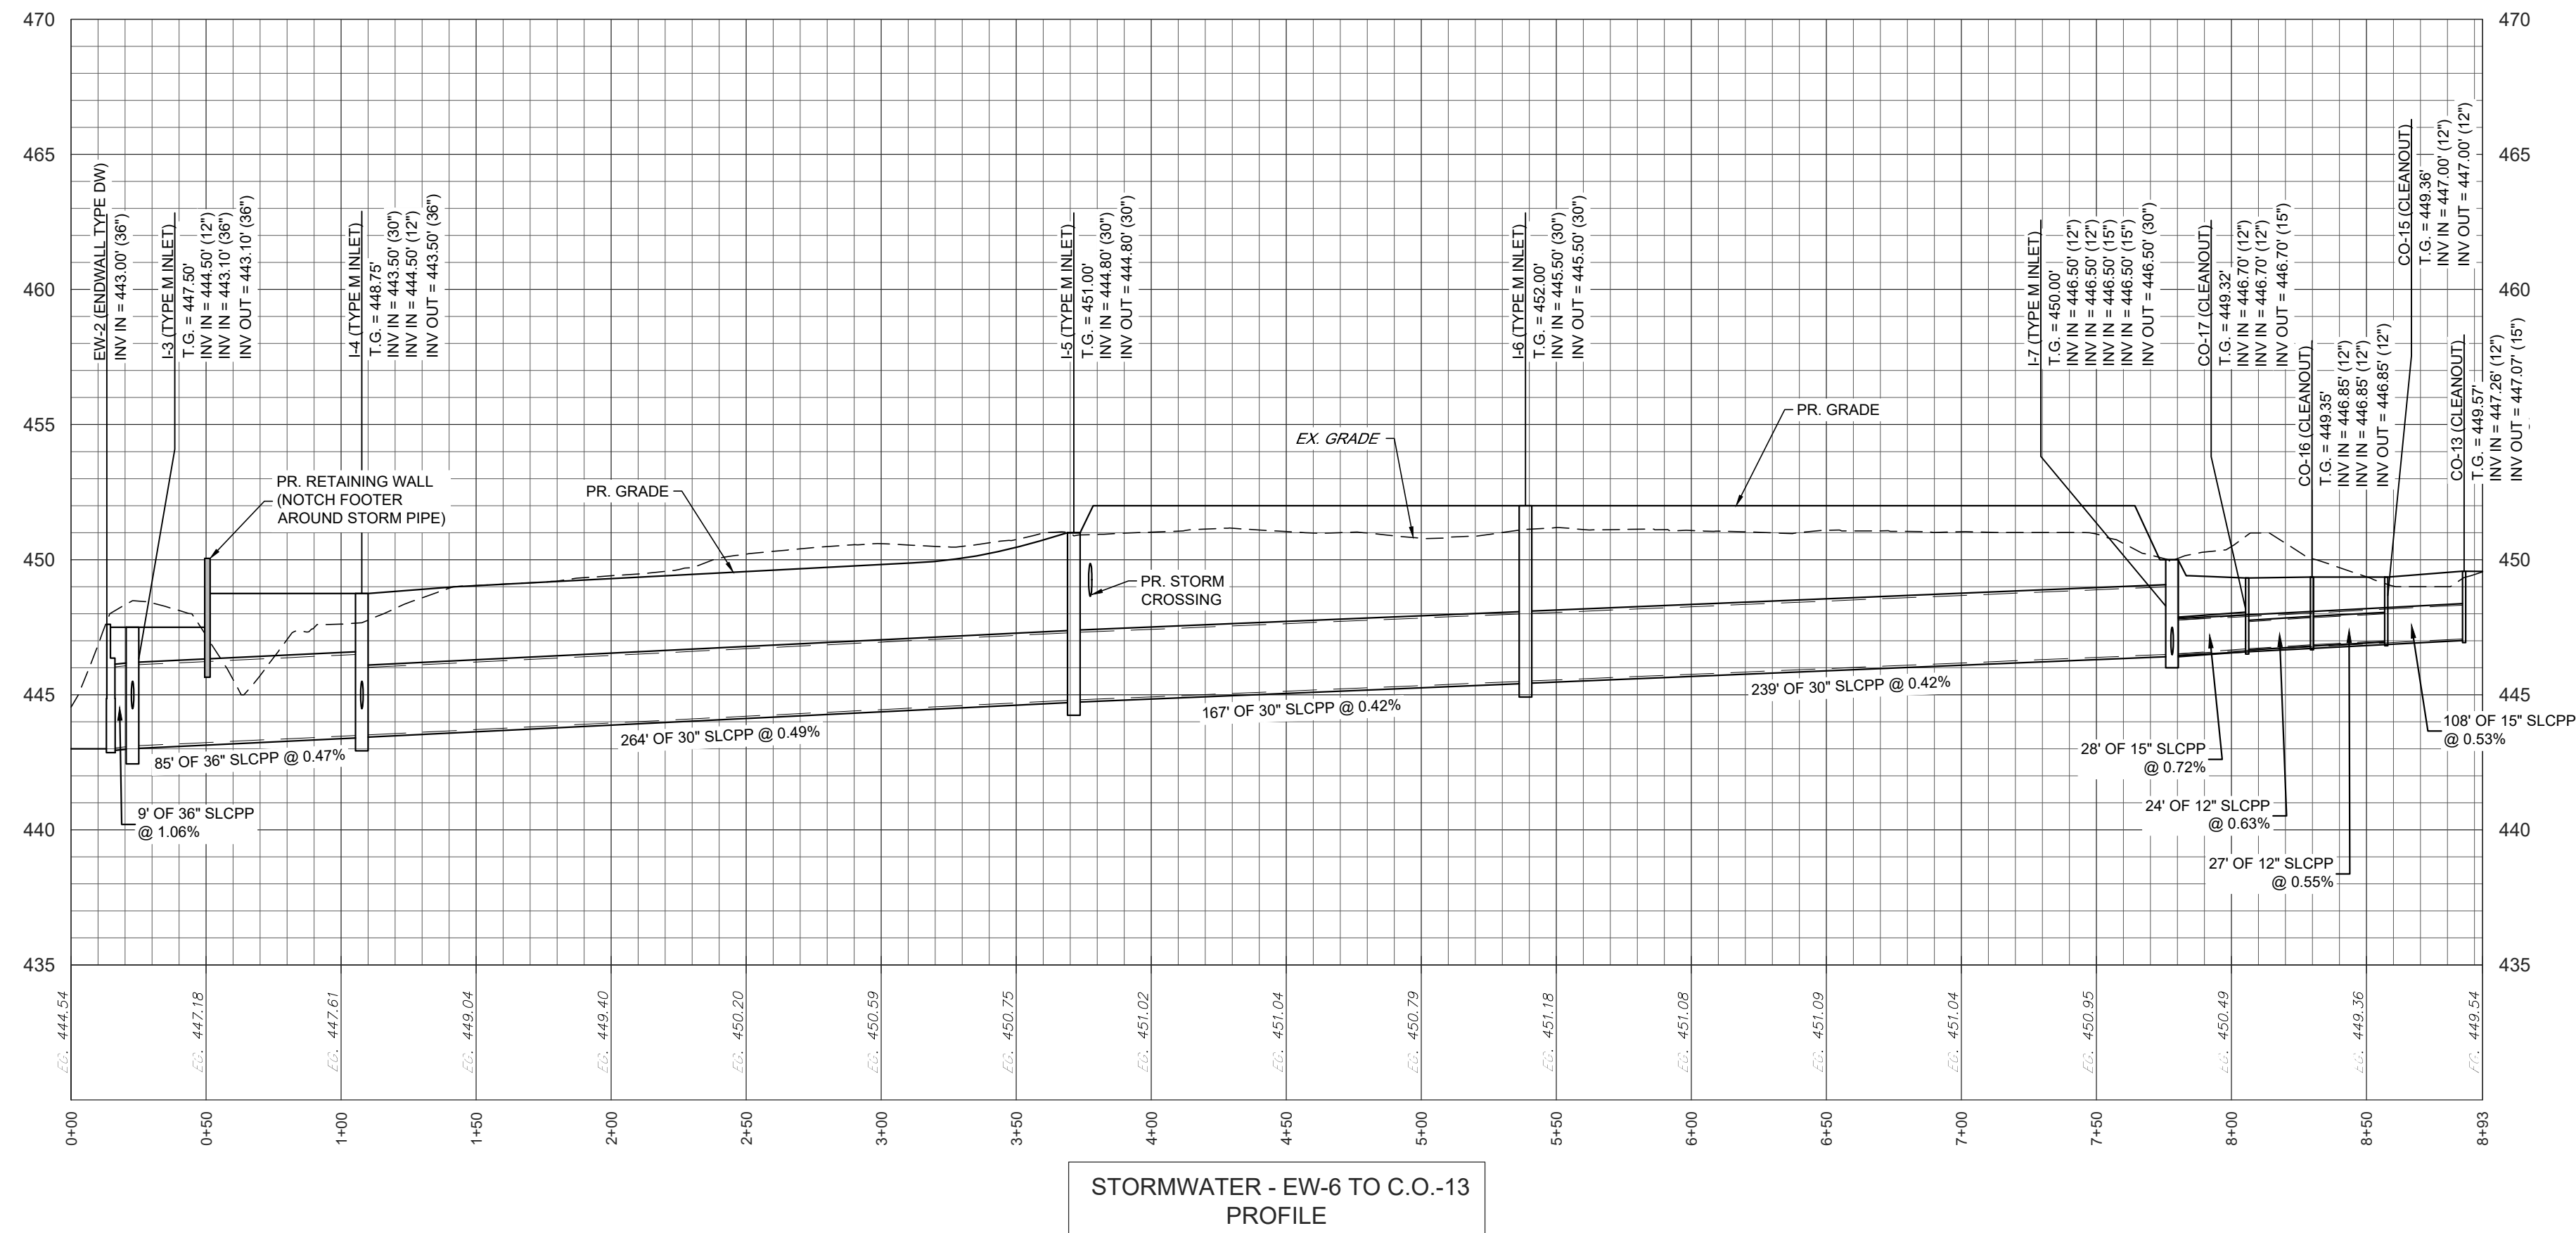



REVISION	DATE	BY

**PROFILES**  
 For  
**PRELIMINARY/FINAL LAND DEVELOPMENT PLANS**  
 For  
**SCOUT COLD LOGISTICS, LLC**  
 located in  
 NORTH LEBANON TOWNSHIP  
 LEBANON County, Pennsylvania




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BASE MAP:	JEC
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CHECKED:	SAS
DATE:	02/26/24
SCALE:	AS NOTED
PROJECT #	2368-23-001

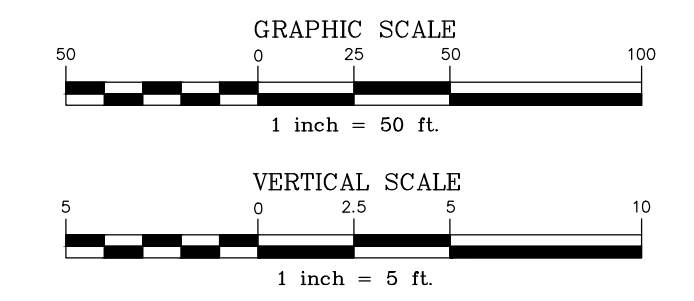

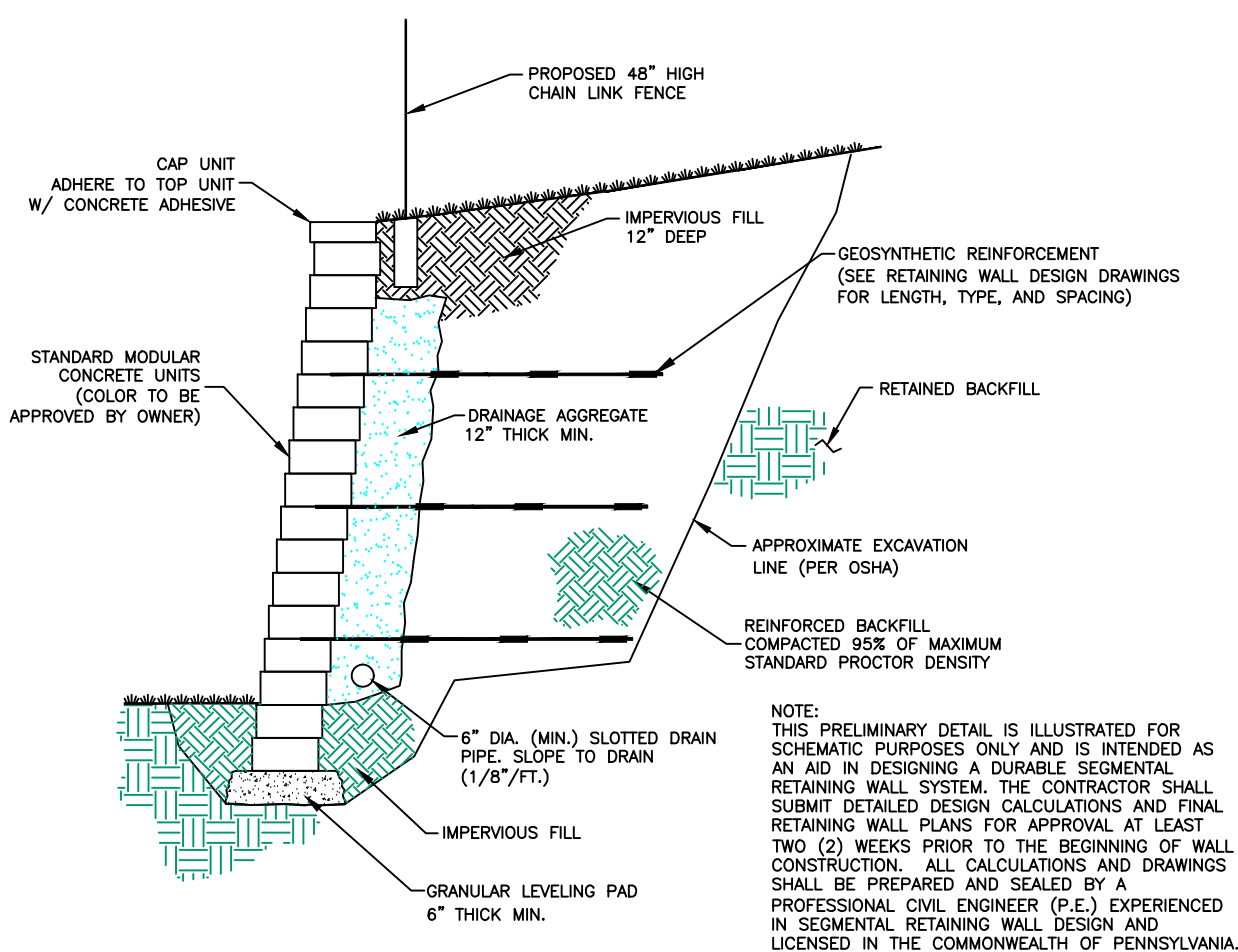


**TYPICAL SECTION-REINFORCED RETAINING WALL**


NO SCALE

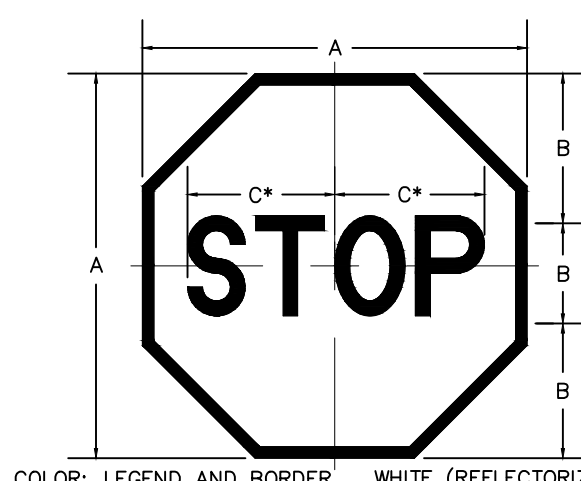

**STOP SIGN DETAIL**  
NO SCALE

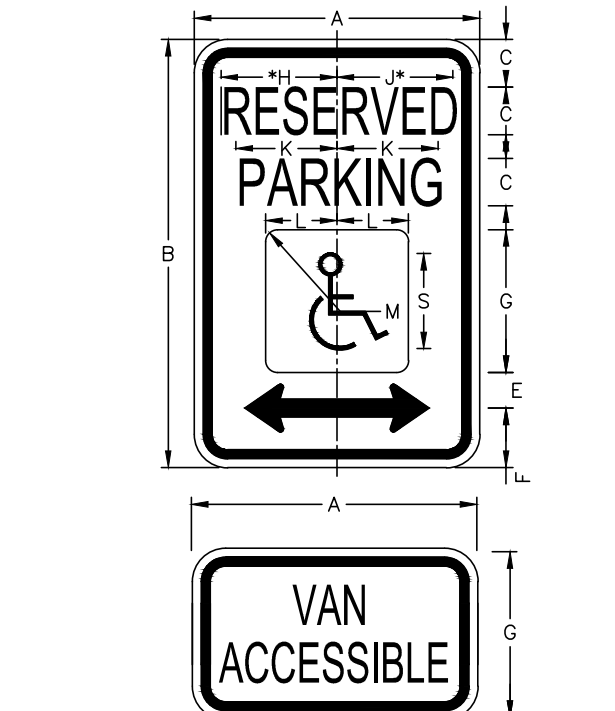


**ADA SIGNAGE DETAIL**  
NO SCALE

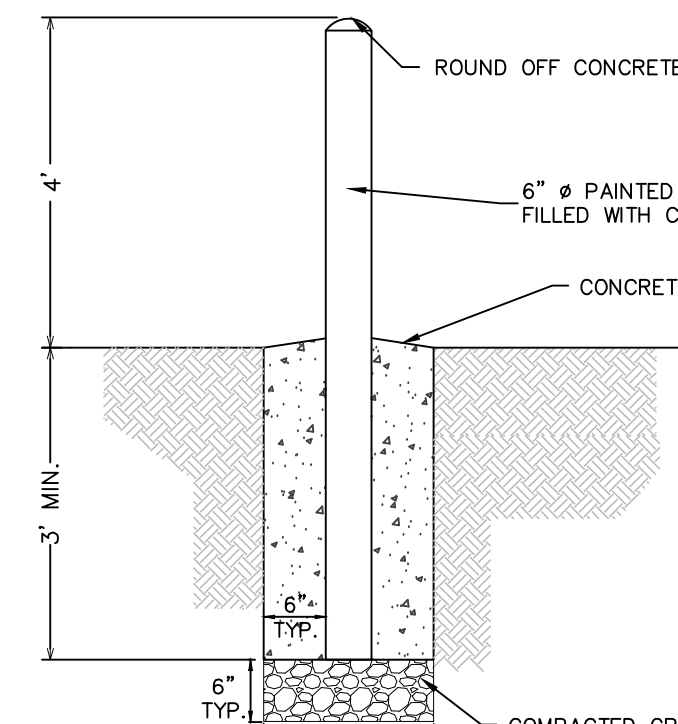


**PIPE BOLLARD DETAIL**

NO SCALE

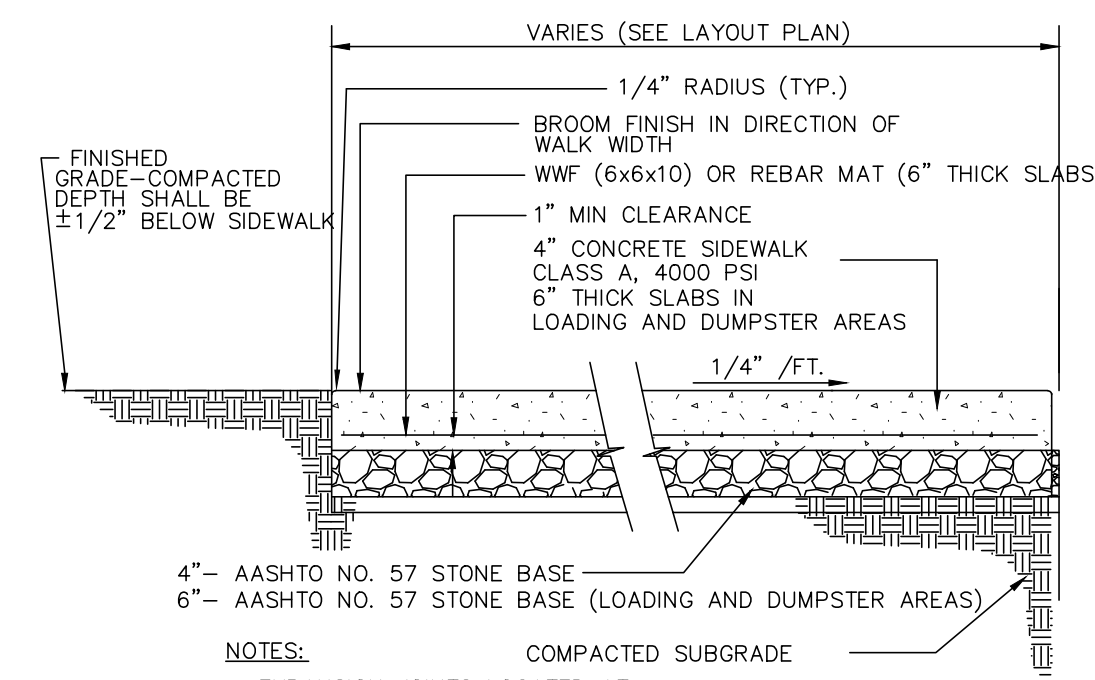


**CONCRETE SIDEWALK DETAIL**  
NO SCALE

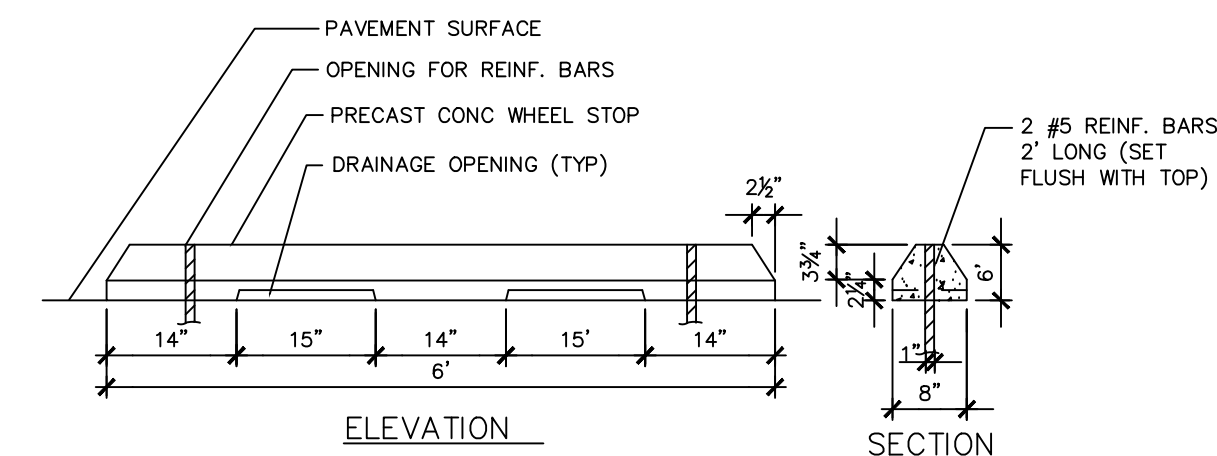


**TYPICAL WHEEL STOP DETAIL**

NO SCALE

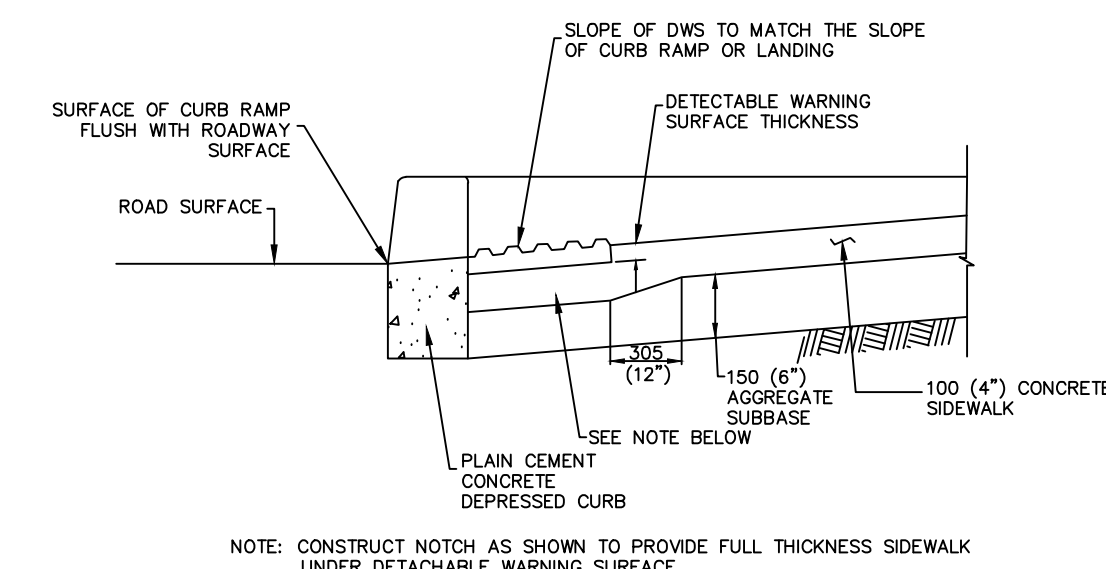


**DETECTABLE WARNING SURFACE DETAIL**

NO SCALE

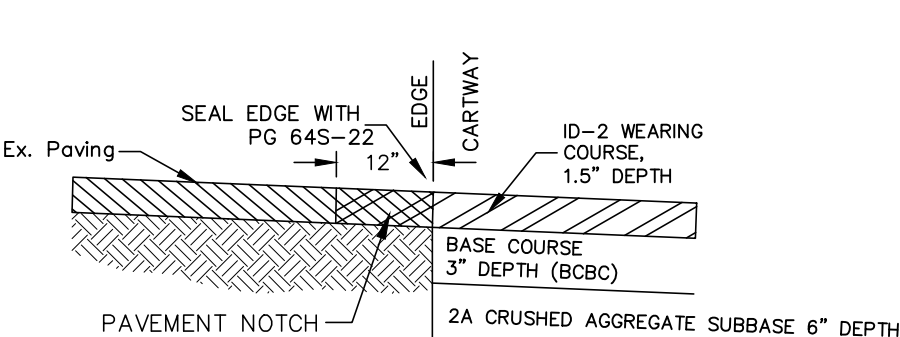


**PAVEMENT NOTCH DETAIL**

NO SCALE

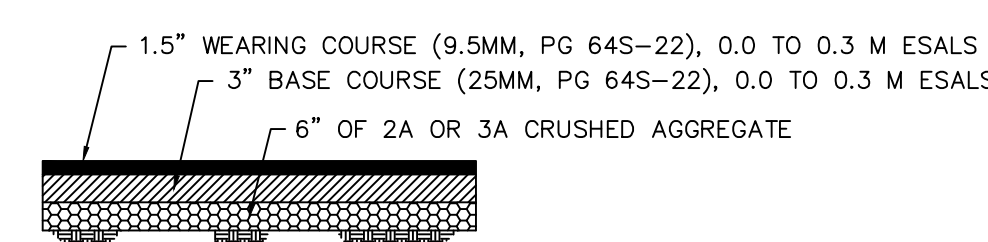


**STANDARD PAVING DETAIL  
(PARKING LOTS ONLY)**

NO SCALE

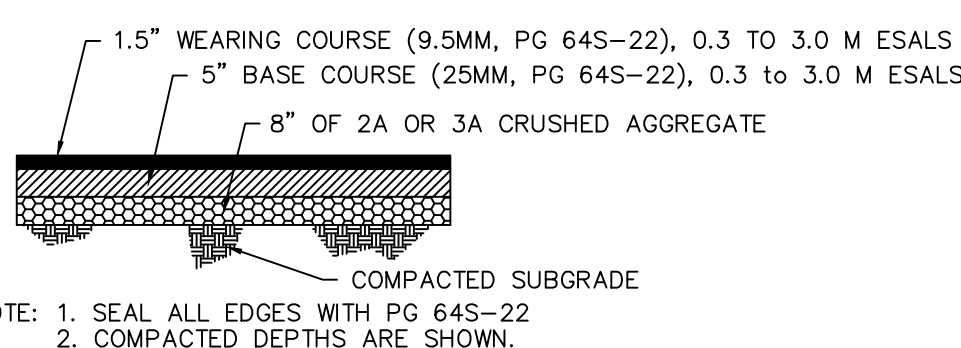


**HEAVY LOADING PAVING DETAIL  
(MAIN ACCESS AND TRUCK  
LOADING/UNLOADING AREA)**

NO SCALE

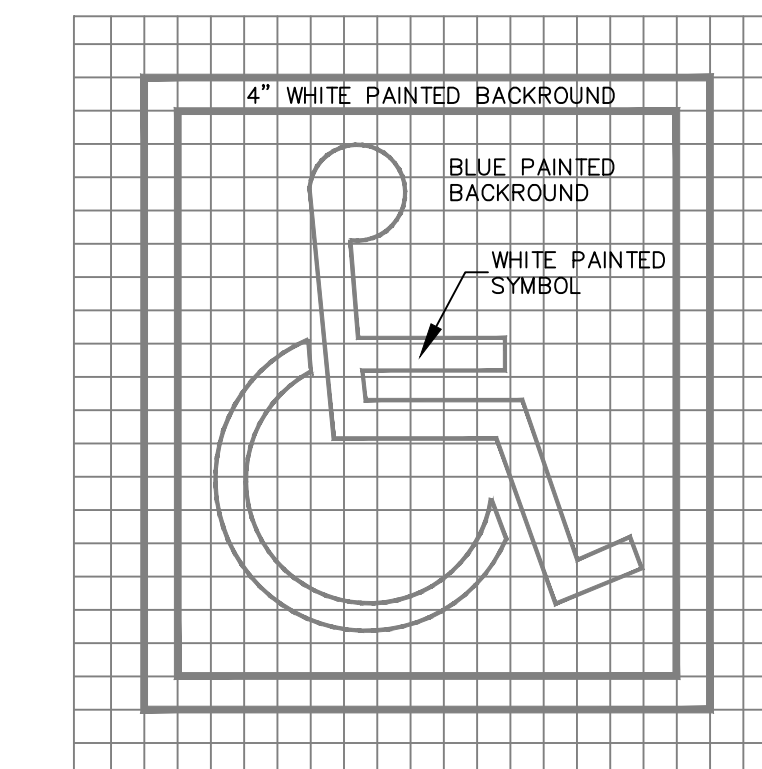


**TYPICAL PAINTED ACCESSIBLE SYMBOL DETAIL**

NO SCALE

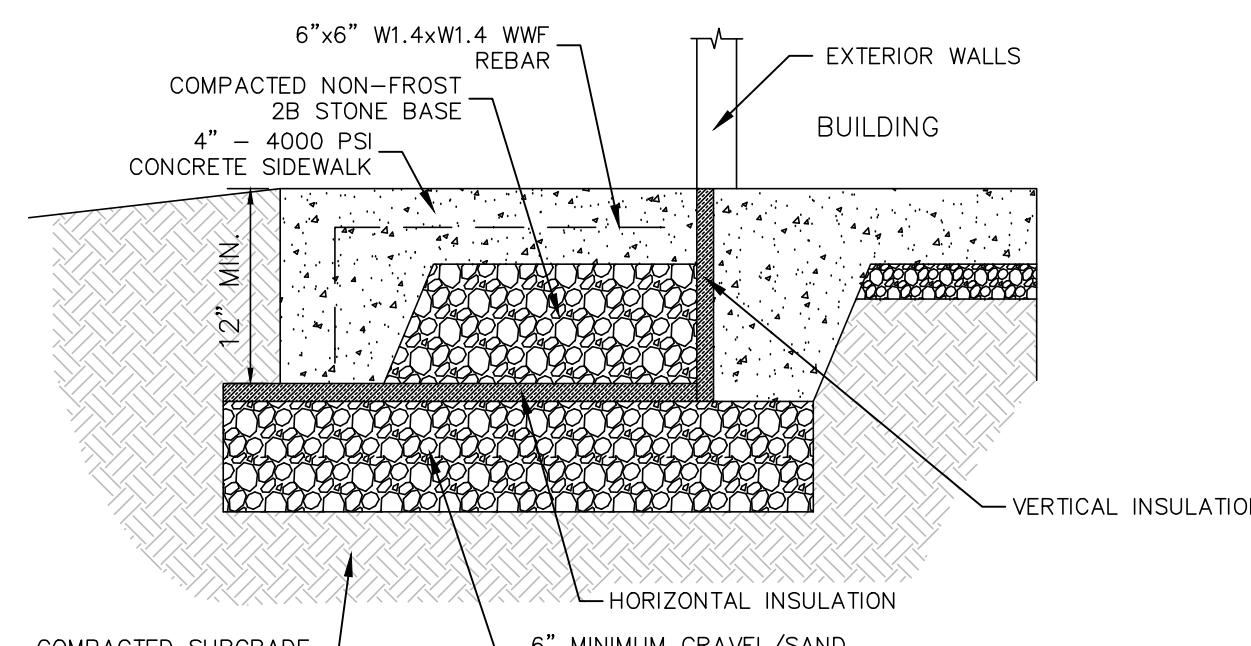


**CONCRETE STOOP DETAIL**

NO SCALE

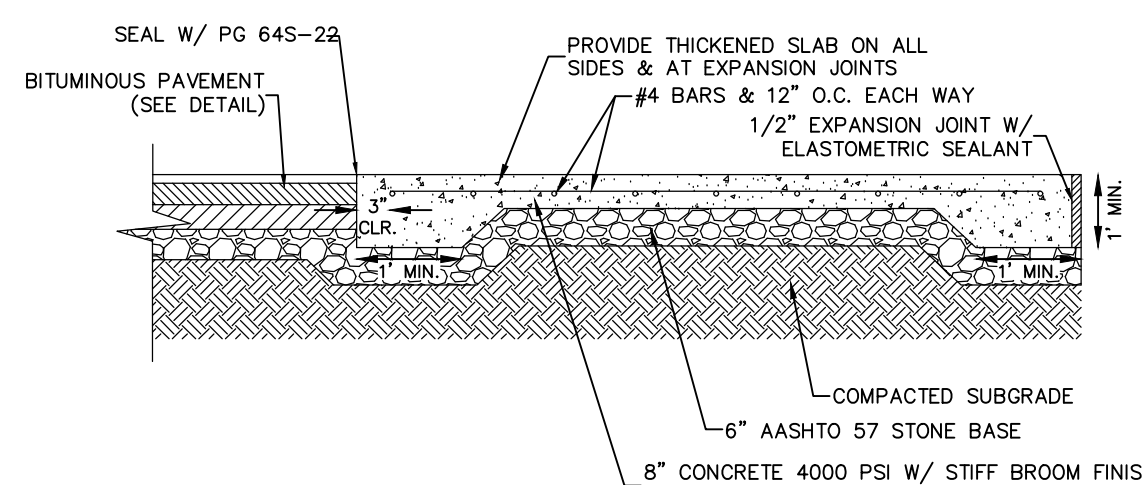


**CONCRETE LOADING AREA DETAIL**

NO SCALE

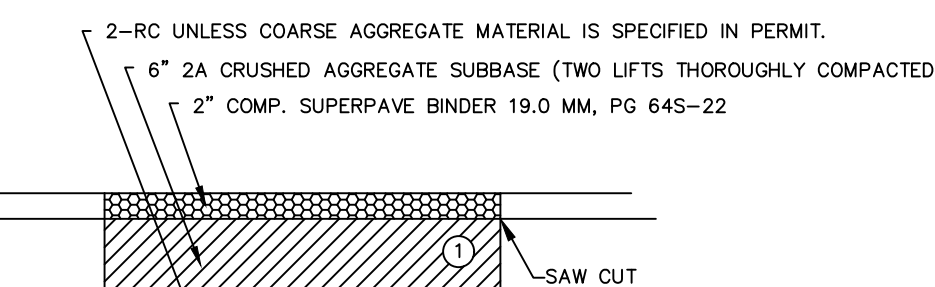


**TEMPORARY PAVEMENT RESTORATION**

NO SCALE

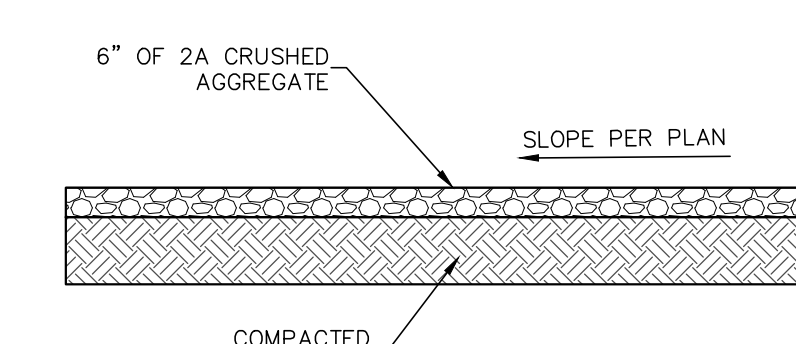


**STONE ACCESS/MAINTENANCE DRIVE DETAIL**

NO SCALE

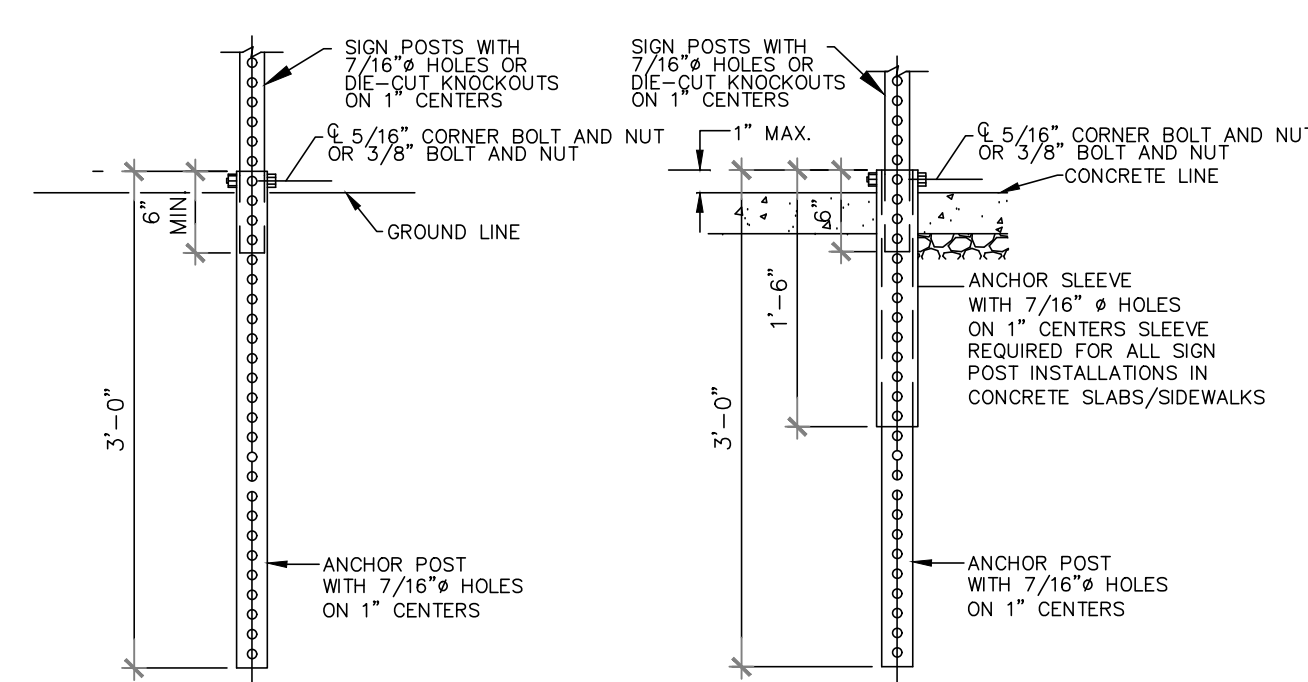

**INSTALLATION DETAIL**  
(STANDARD) (CONCRETE)

**INSTALLATION NOTES:**  
1. ALL SIGNS LOCATED ALONG STREETS SHALL BE MOUNTED ON BREAKAWAY SIGN POSTS.

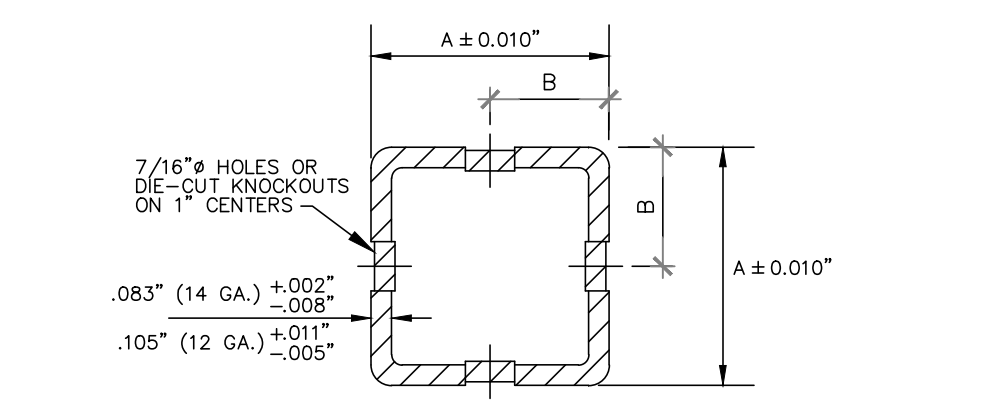


SIGN POST		ANCHOR POST		ANCHOR SLEEVE*		SPRICE SLEEVE	
SIZE	DIMENSION	SIZE	DIMENSION	SIZE	DIMENSION	SIZE	DIMENSION
1.75"	1 3/4" x 7/8"	2.25"	2 1/4"	2.25"	2 1/4"	1.75"	1 1/2" x 3/4"
2.25"	2 1/4"	2.25"	2 1/4"	2.25"	2 1/4"	1.75"	1 1/2" x 3/4"
2.25"	2 1/4"	2.25"	2 1/4"	2.25"	2 1/4"	2.00"	2" x 1 1/4"

**SQUARE STEEL POSTS**  
12 AND 14 GAGE - 60 KSI

**SITE SIGN POST SIGNAGE DETAIL**

NO SCALE

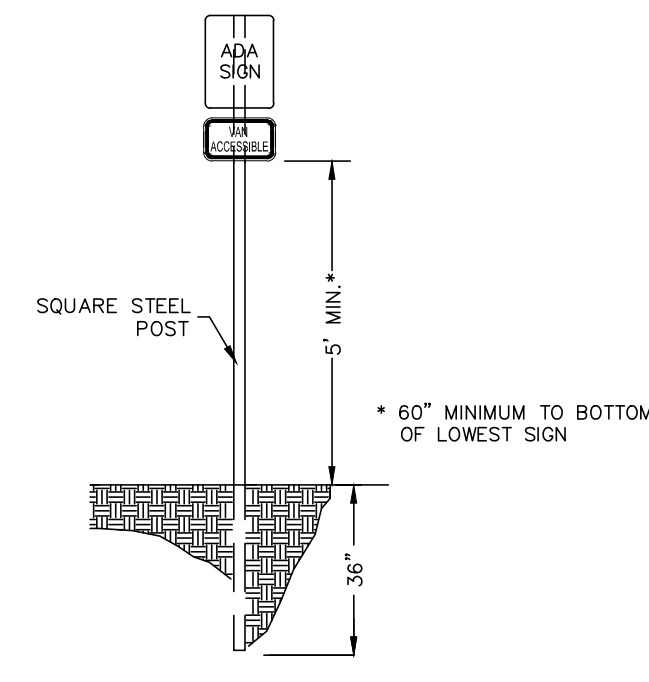

**ADA SIGN POST DETAIL**

NO SCALE

POST SCHEDULE			
# 14 GAUGE POST, 10" MAX HEIGHT FROM GROUND TO CENTER OF SIGN PLATE			
SIGN SIZE	POST SIZE	SIGN SIZE	POST SIZE
8"x8"	1.75"	30"x24"	1.75"
12"x18"	1.75"	30"x24"	1.75"
12"x24"	1.75"	30"x24"	1.75"
12"x30"	1.75"	30"x36"	2.0"
12"x36"	1.75"	30"x48"	2.0"
12"x48"	1.75"	30"x48"	2.0"
18"x18"	1.75"	36"x36"	2.0"
18"x24"	1.75"	36"x36"	2.0"
18"x24"	1.75"	36"x24"	2.0"
18"x24"	1.75"	48"x36"	2.0"
18"x24"	2.0"	48"x36"	TWO POSTS
24"x12"	1.75"	60"x24"	TWO POSTS
24"x12"	1.75"	60"x24"	TWO POSTS
24"x36"	2.0"	60"x24"	TWO POSTS
24"x48"	2.0"	60"x36"	TWO POSTS

**INSTALLATION NOTES:**  
1. MATERIALS AND WORKMANSHIP SHALL BE IN ACCORDANCE WITH PUB. 408  
2. SIGN POSTS AND SPICE SLEEVES SHALL HAVE 7/16" DIAMETER HOLES OR DIE-OUT KNOCKOUTS ON 1" CENTERS ON ALL FOUR SIDES. ANCHOR POSTS AND ANCHOR SLEEVES SHALL HAVE 7/16" DIAMETER HOLES ON 1" CENTERS ON ALL FOUR SIDES.  
3. BOLTS AND NUTS SHALL BE ASTM-307, GRADE 2  
4. DRIVE RIVETS MAY BE USED TO FASTEN SIGN BLANKS TO THE SIGN POST.

**STOP SIGN POST DETAIL**

NO SCALE


BY	DATE	REVISION

BY	DATE	REVISION

DETAILS  
PRELIMINARY/FINAL LAND DEVELOPMENT PLANS  
For  
**SCOUT COLD LOGISTICS, LLC**  
located in  
NORTH LEBANON TOWNSHIP  
LEBANON County, Pennsylvania


FIELD CREW: MOD, JEC  
BASE MAP: JEC  
DRAWN: CDS  
DESIGN: CDS  
CHECKED: SAS  
DATE: 02/26/24  
SCALE: AS NOTED  
PROJECT #2368-23-001



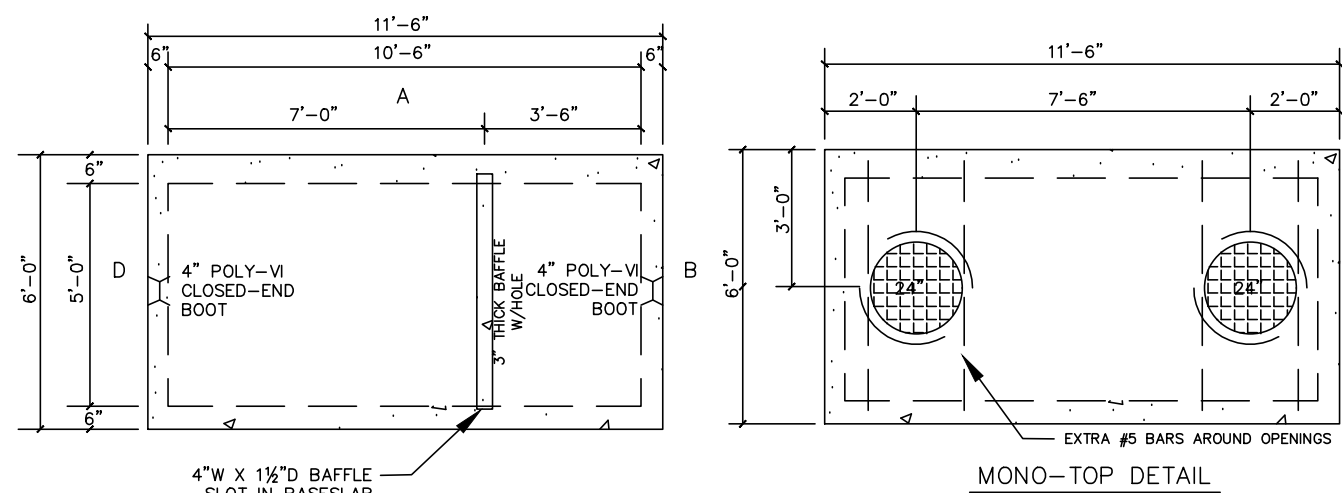


**GREASE TRAP DETAIL**

NO SCALE

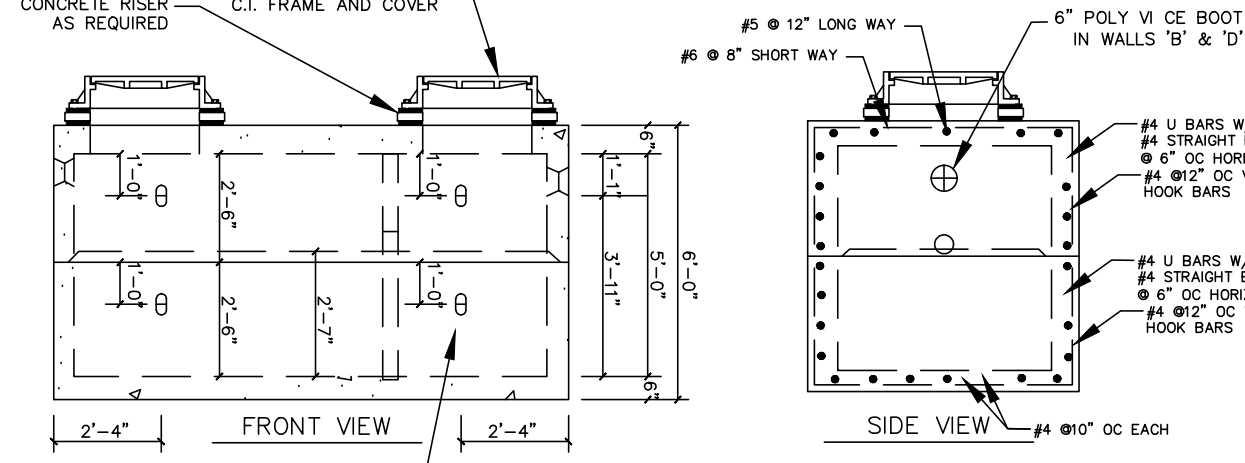


WALLS	PIPE SIZE	PIPE INVERT	HOLE UP	HOLE UP	PRODUCTION YARDAGE	WEIGHTS	REINFORCEMENT
B	4" PVC	+3.92	4" RUBBER BOOT	47"	BASE 2.61 CYDS	11,361	#4 @ 10 O.C. W/ 2" COVER
D	6" PVC	+4.17	6" RUBBER BOOT	50"	WALL		VERT. #4 @ 12" V. (DEPTH)
							HORIZ. #4 @ 12" H. (DEPTH)
							#4 @ 12" O.C. W/ 2" COVER
BAFFLE	4" PVC	+2.58	6"	2'-7"	MONO-TOP 2.68 CYDS	10,861	#4 @ 12" O.C. W/ 2" COVER
					BAFFLE 0.24 CYDS	987	#4 @ 12" O.C. W/ 2" COVER
					CASTING 3170000	150	(2) USF 170 RINGS
					REMARKS: 30000207	130	(2) USF 170 RINGS - CAL INTERLOCK
							STEEL WT. CONC. WT.

NOTES:  
 1. CONCRETE 28 DAY COMP. STRENGTH FC = 4000 PSI.  
 2. PRECAST STRUCTURES ARE PRODUCED TO MEET OR EXCEED ASTM SPECIFICATIONS.  
 3. CONTRACTOR TO VERIFY SIZE AND LOCATION OF ALL OPENINGS.  
 4. ALL INTERNAL PIPING DONE BY OTHERS.  
 5. JOINT SEALANT INCLUDED.  
 6. DIMENSIONS SHOWN ON DETAIL ARE BASED UPON AN 800-GAL. TANK.  
 60"x120"x60"

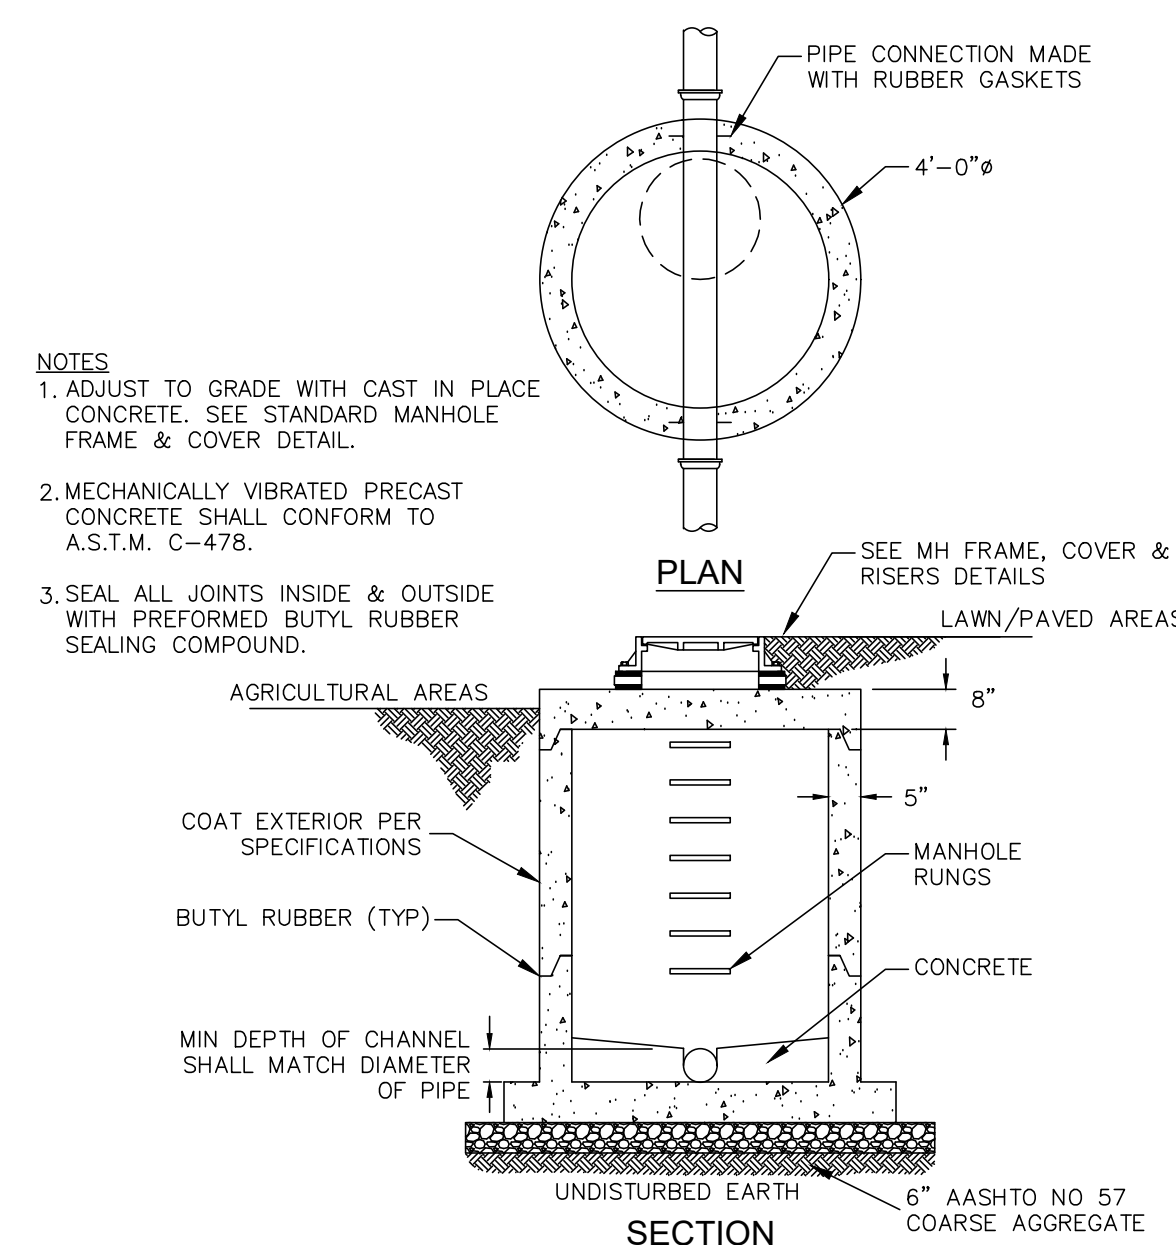


**SAMPLING MANHOLE DETAIL**

NO SCALE

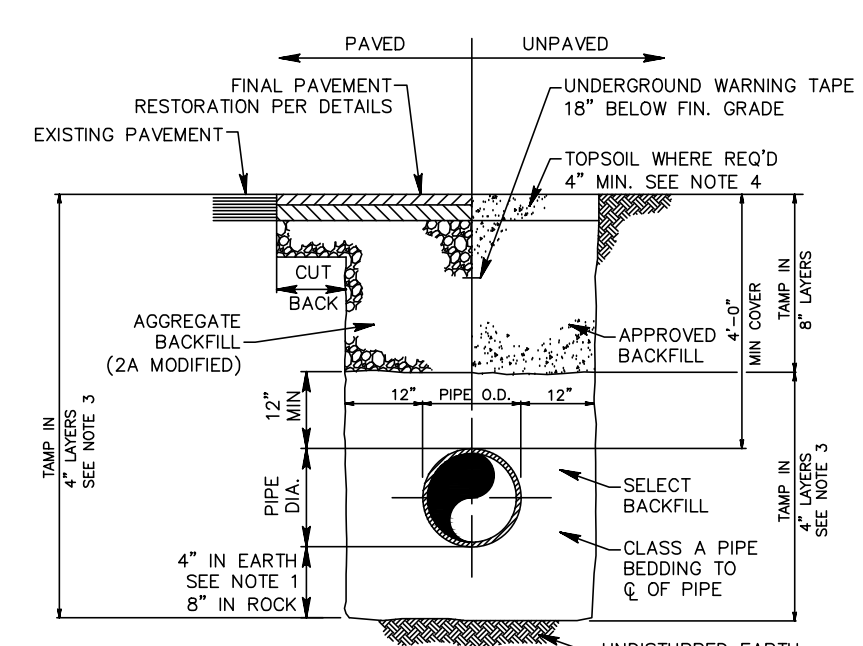


**TRENCH BACKFILL DETAIL**

NO SCALE

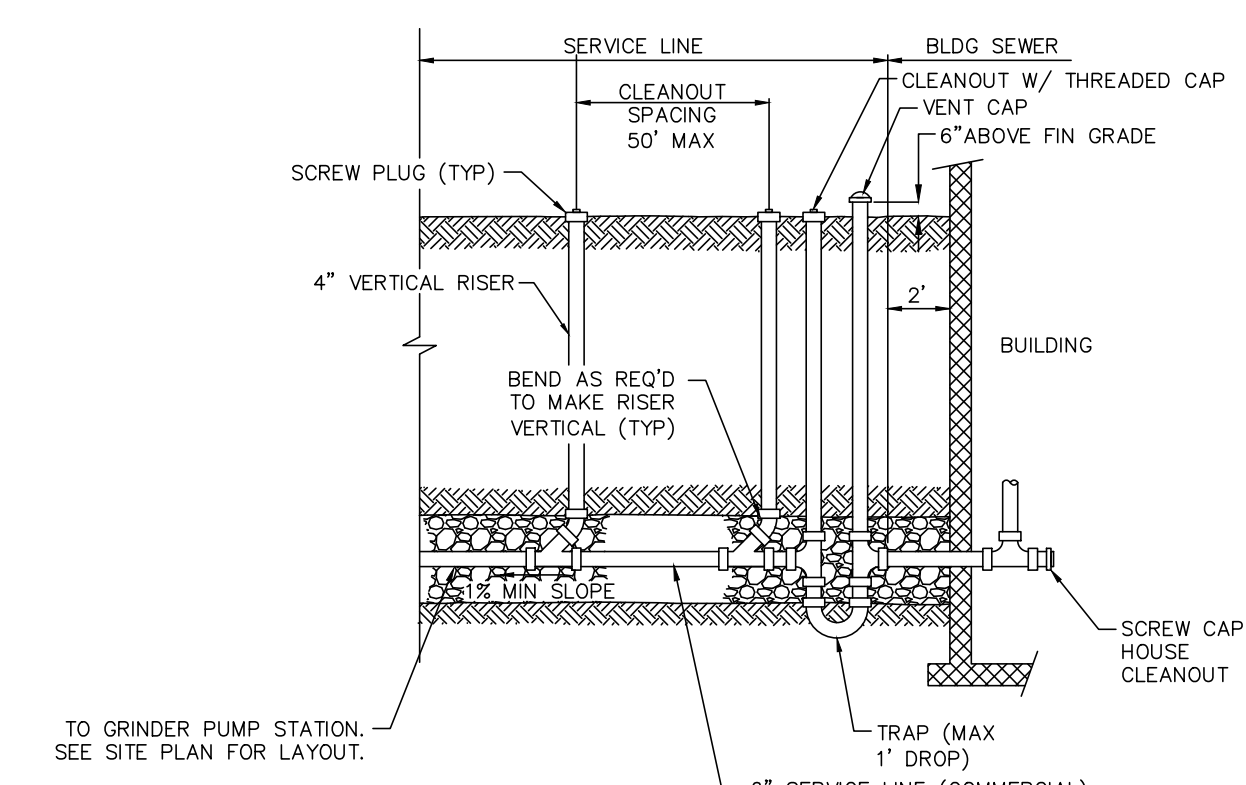


**BUILDING SEWER DETAIL**

NO SCALE

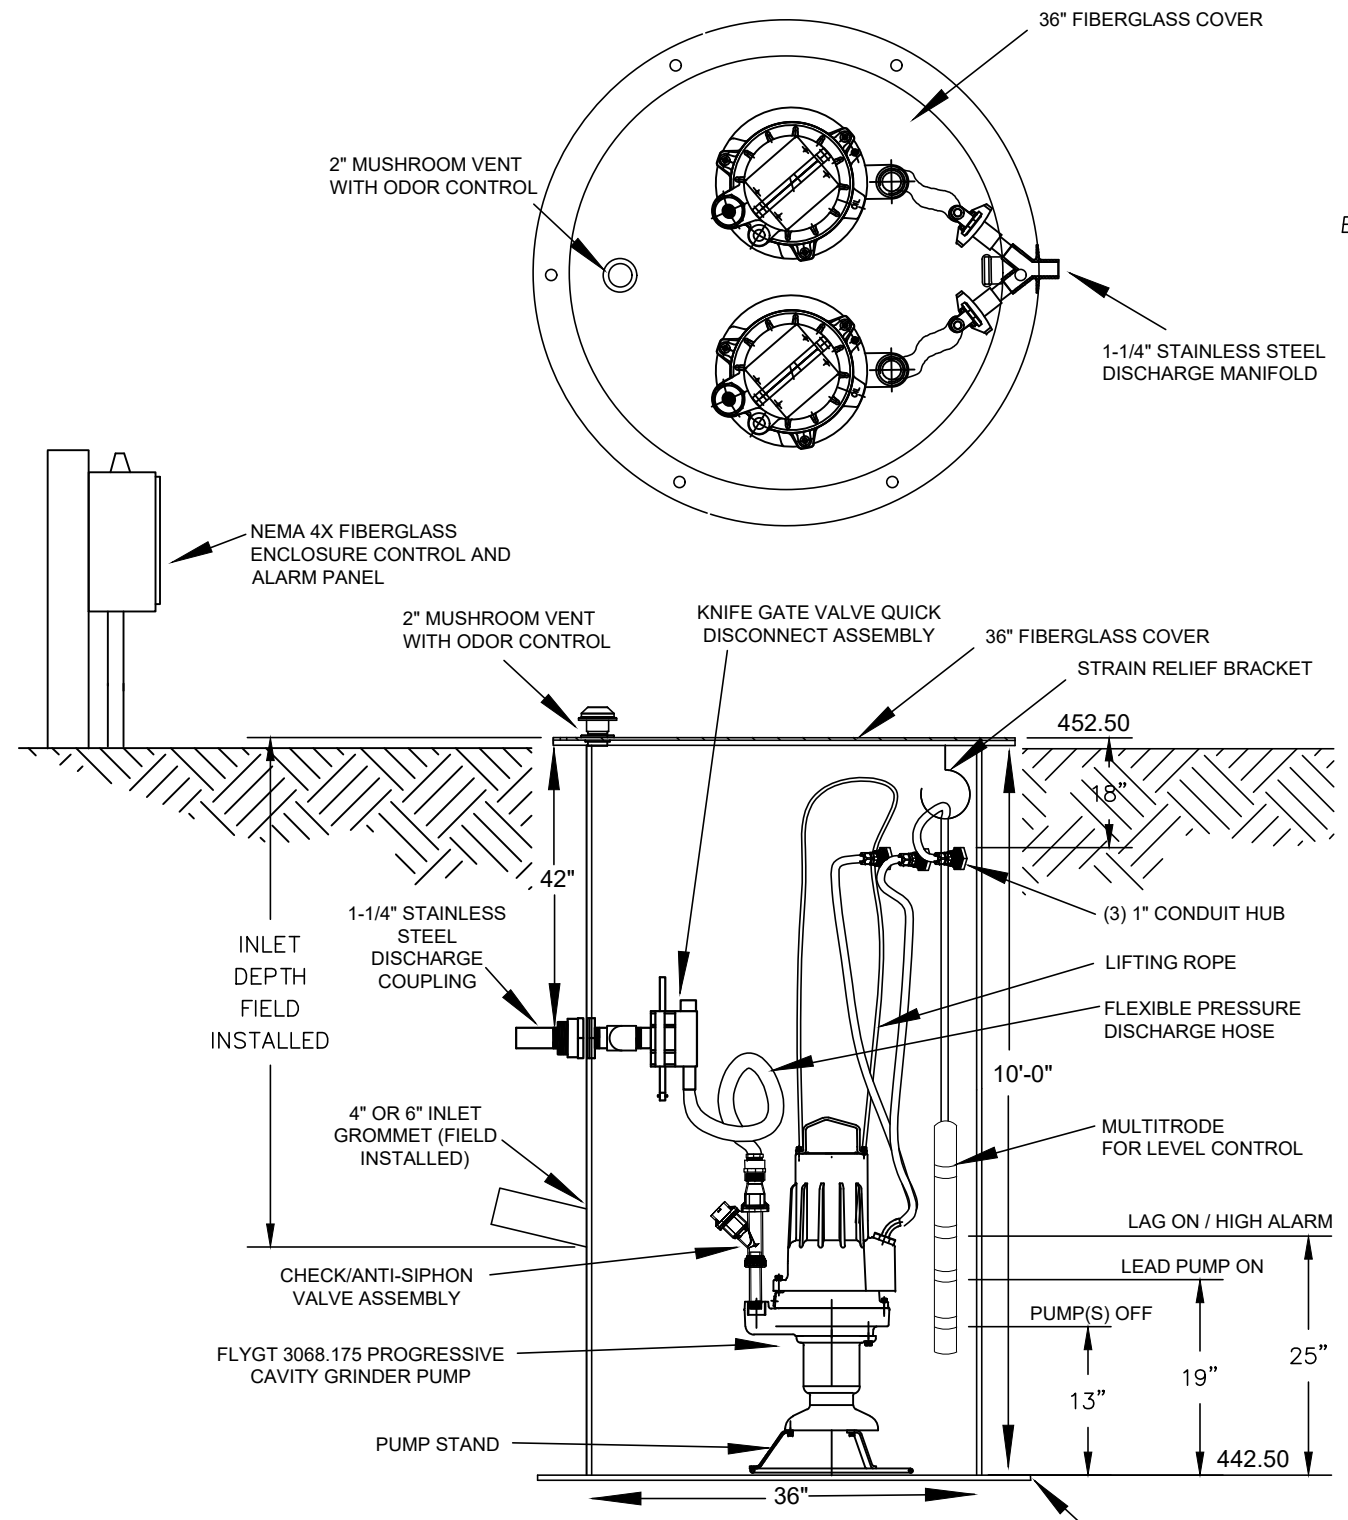


**DUPLEX GRINDER PUMP DETAIL**

NO SCALE

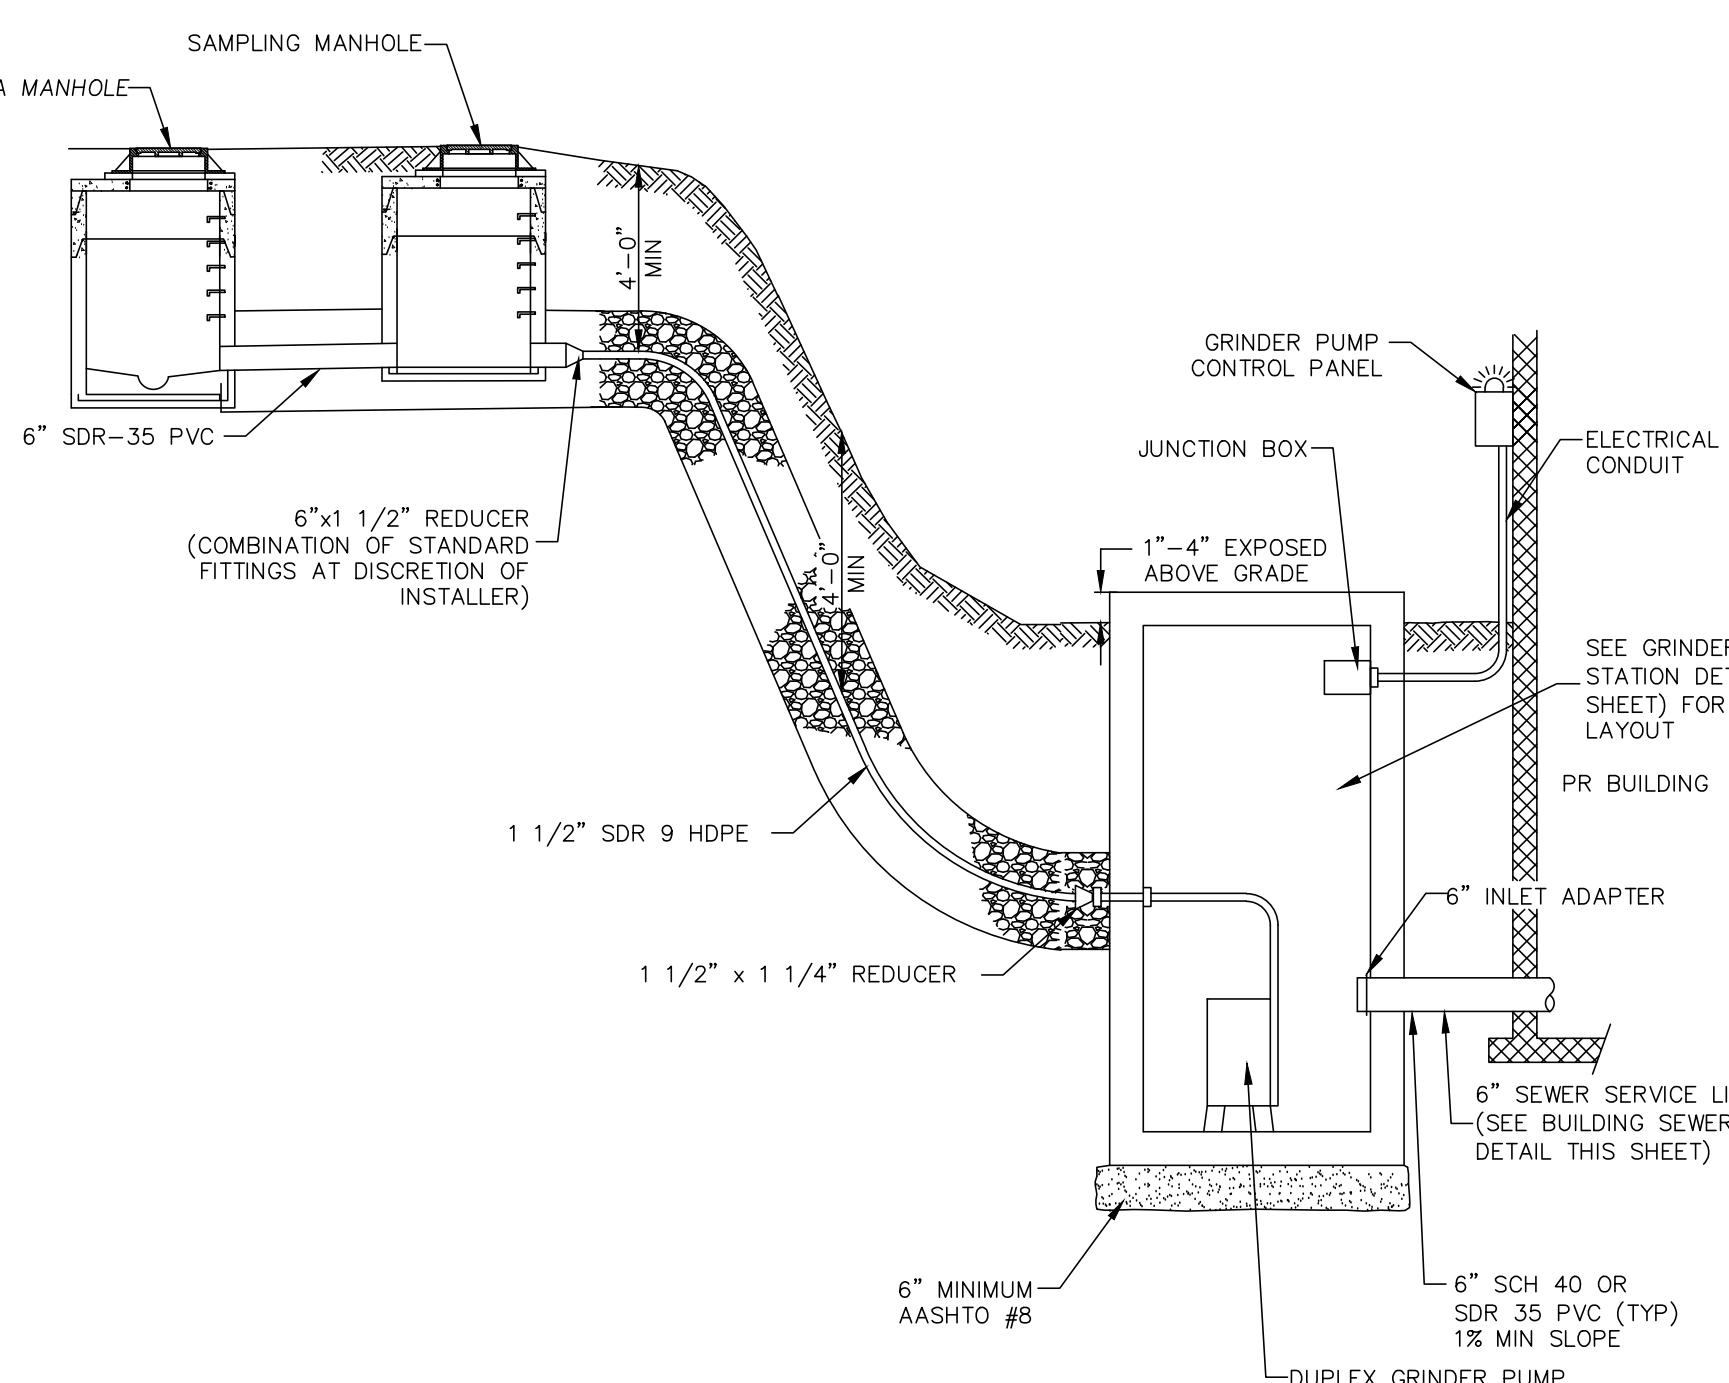


**GRINDER PUMP LATERAL CONNECTION DETAIL**

NO SCALE

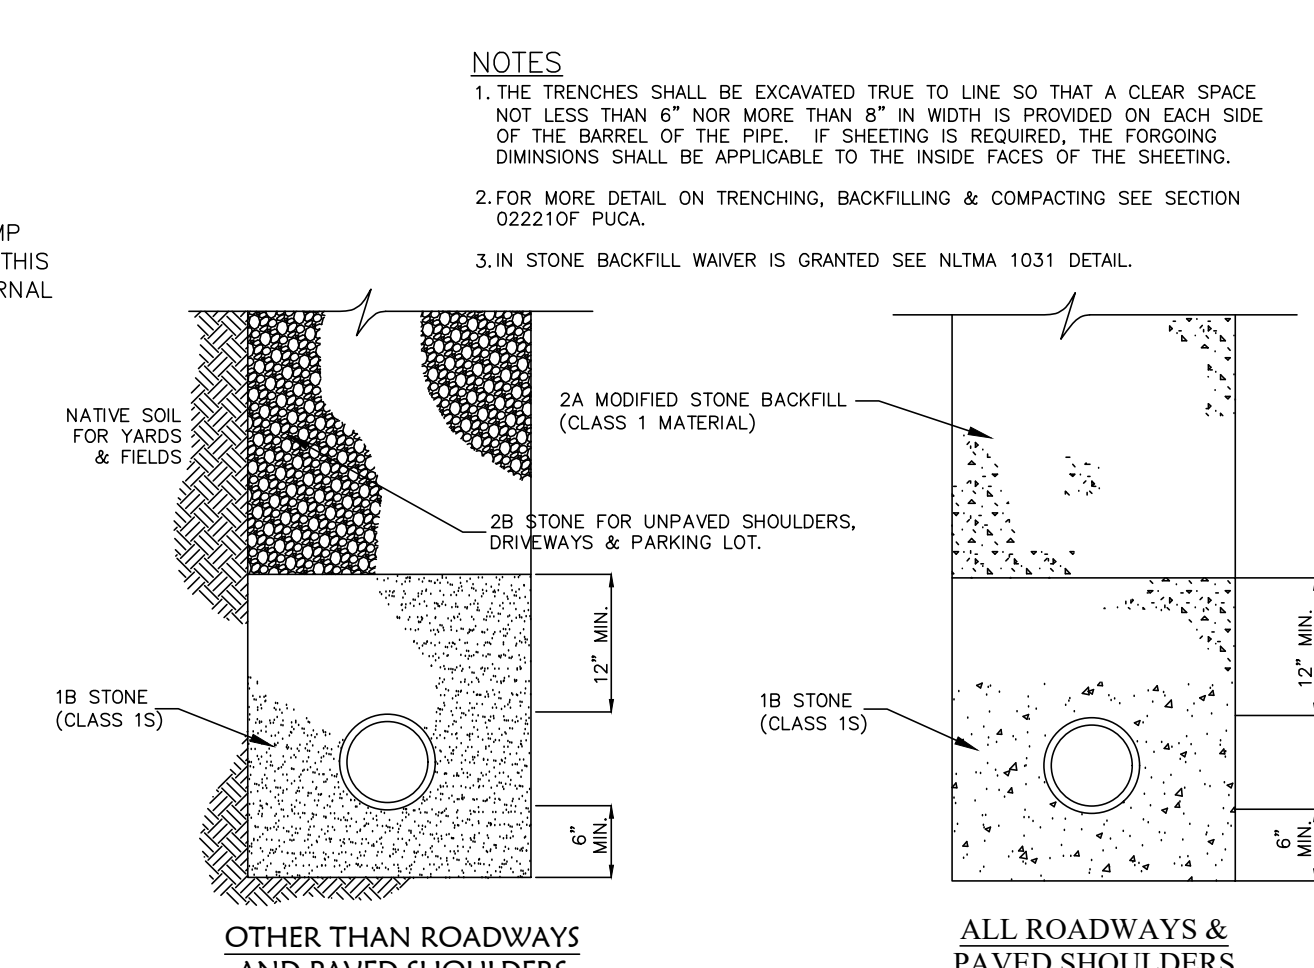


**TYPICAL TRENCH BACKFILL FOR SANITARY SEWER**

NO SCALE

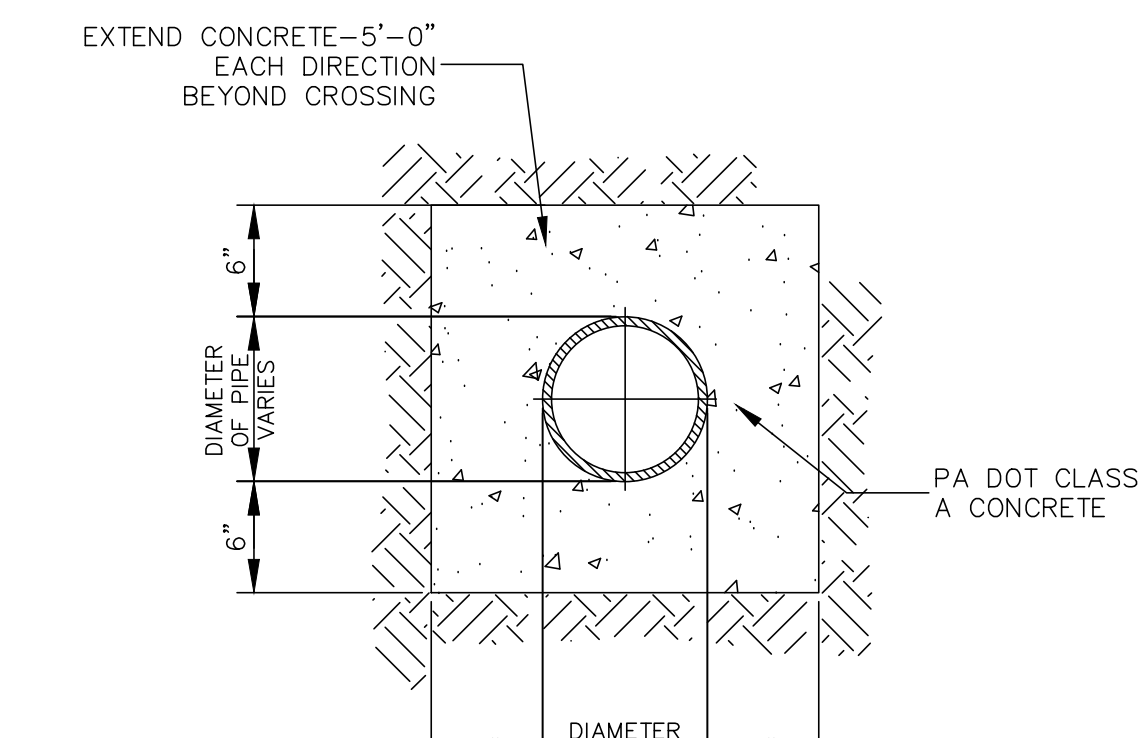

**UTILITY ENCASEMENT DETAIL**

NO SCALE

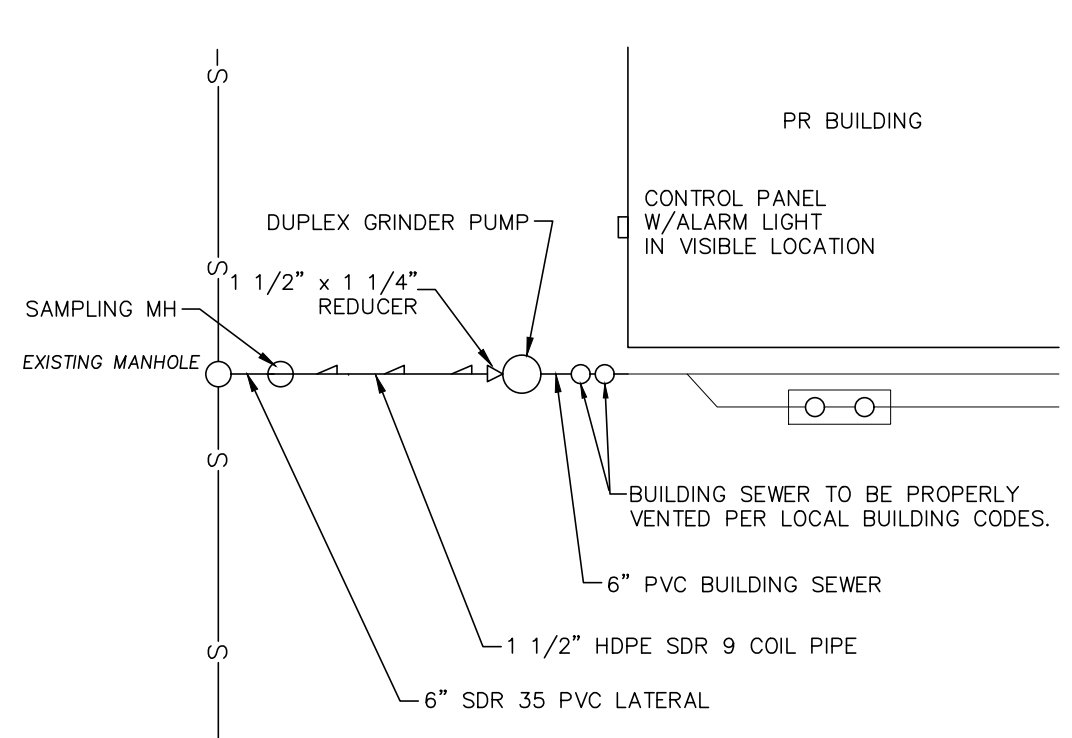


**GRINDER PUMP SCHEMATIC**

NO SCALE

NO.	DATE	BY	REVISION

**PRELIMINARY/FINAL LAND DEVELOPMENT PLANS**  
 For  
**SCOUT COLD LOGISTICS, LLC**  
 located in  
 NORTH LEBANON TOWNSHIP  
 LEBANON County, Pennsylvania

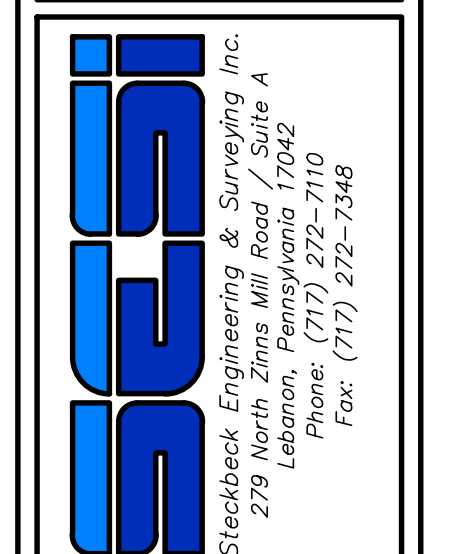

FIELD CREW: MOD, JEC
BASE MAP: JEC
DRAWN: CDS
DESIGN: CDS
CHECKED: SAS
DATE: 02/26/24
SCALE: AS NOTED
PROJECT # 2368-23-001

**EROSION AND SEDIMENT CONTROL NOTES:**  
 FAILURE TO CORRECTLY INSTALL SEDIMENT CONTROL FACILITIES OR FAILURE TO PREVENT SEDIMENT LADEN RUNOFF FROM LEAVING THE CONSTRUCTION SITE OR FAILURE TO TAKE CORRECTIVE ACTIONS TO IMMEDIATELY RESOLVE FAILURES OF SEDIMENT CONTROL FACILITIES MAY RESULT IN ADMINISTRATIVE, CIVIL AND/OR CRIMINAL PENALTIES BEING INSTITUTED BY THE PENNSYLVANIA DEPARTMENT OF ENVIRONMENTAL PROTECTION AS DEFINED IN SECTION 602 OF THE CLEAN STREAMS LAW OF PENNSYLVANIA. THE CLEAN STREAMS LAW PROVIDES FOR UP TO \$10,000 PER DAY IN CIVIL PENALTIES, UP TO \$10,000 IN SUMMARY CRIMINAL PENALTIES, AND UP TO \$25,000 IN MISDEMEANOR CRIMINAL PENALTIES FOR EACH VIOLATION.


SEDIMENT TRACKED ONTO ANY PUBLIC ROADWAY OR SIDEWALK SHALL BE RETURNED TO THE CONSTRUCTION SITE BY THE END OF EACH WORK DAY AND DISPOSED IN THE MANNER DESCRIBED IN THIS PLAN. IN NO CASE SHALL THE SEDIMENT BE WASHED, SHOVELED OR SWEEPED INTO ANY ROADSIDE DITCH, STORM SEWER, OR SURFACE WATER.

THESE PLANS INDICATE CRITICAL AREAS FOR EROSION AND SEDIMENT CONTROL PLACEMENT BUT DO NOT RELIEVE THE CONTRACTOR FROM PROVIDING ADDITIONAL CONTROLS AS SITE CONDITIONS WARRANT. THE ENVIRONMENTAL COMPLIANCE MANAGER FOR THE PROJECT AND OR CONSERVATION DISTRICT MAY DIRECT THE CONTRACTOR TO INSTALL E&S BMPs NOT DEPICTED ON THESE DRAWINGS IN ORDER TO PROTECT DOWN GRADIENT AREAS FROM EROSION AND SEDIMENTATION DURING CONSTRUCTION.

UNTIL THE SITE IS STABILIZED, ALL EROSION AND SEDIMENT BMPs SHALL BE MAINTAINED PROPERLY. MAINTENANCE SHALL INCLUDE INSPECTIONS OF ALL EROSION AND SEDIMENT BMPs AFTER EACH MEASURABLE RAINFALL EVENT AND ON A WEEKLY BASIS. ALL PREVENTATIVE AND REMEDIAL MAINTENANCE WORK, INCLUDING CLEAN OUT, REPAIR, REPLACEMENT, REGRAVING, RESEEDING, RE-MULCHING AND RE-NETTING MUST BE PERFORMED IMMEDIATELY. IF THE E&S BMPs FAIL TO PERFORM AS EXPECTED REPLACEMENT BMPs, OR MODIFICATIONS OF THOSE INSTALLED WILL BE REQUIRED, THE VISUAL SITE INSPECTION REPORT FORM (3800-FM-BCW0271a), OR AN EQUIVALENT ELECTRONIC FORM PROVIDING THE SAME INFORMATION, MUST BE USED TO DOCUMENT THE REQUIRED SITE INSPECTIONS.


INSPECTION AND MAINTENANCE OF ALL EROSION AND SEDIMENT CONTROL MEASURES SHALL BE CONDUCTED AND DOCUMENTED BY COMPLETING THE VISUAL SITE INSPECTION REPORT (PA DEP FORM 3800-FM-BCW0271a DATED 12/20/19). INSPECTIONS SHALL OCCUR WEEKLY AND AFTER EACH MEASURABLE RAINFALL EVENT (0.25" DEPTH OR GREATER).

**E&S FEATURES**



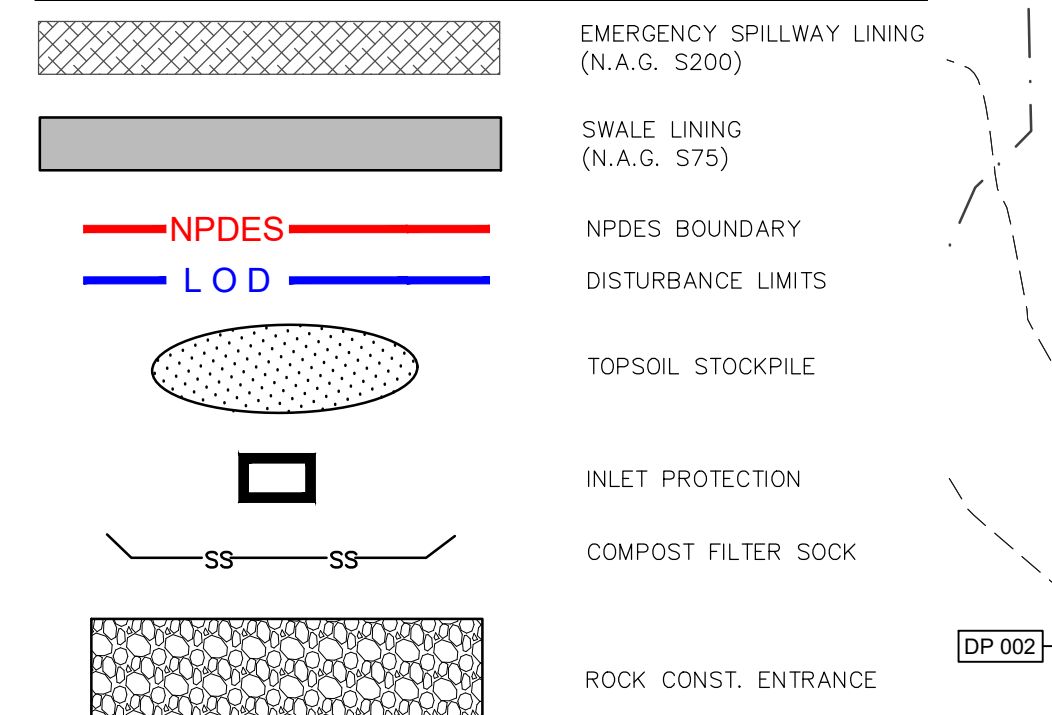


Map Symbol	Soil Name	Slope	Hydrologic Group
DIB	Duffield silt loam	3-8%	B
HaB	Hagerstown silt loam	3-8%	B
HeB	Hagerstown-Rock outcrop complex	3-8%	B
No	Noils variant silt loam	-	B
US	Urban land-Hagerstown complex	-	B

**PROPOSED FEATURES**

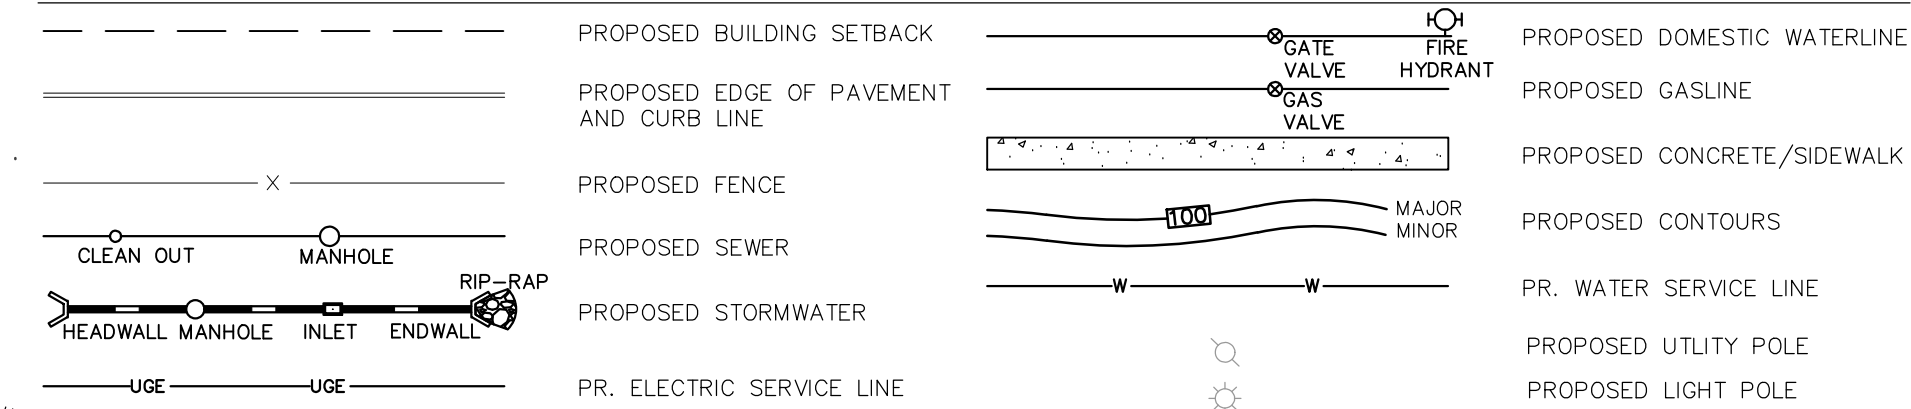

**EXISTING FEATURES**

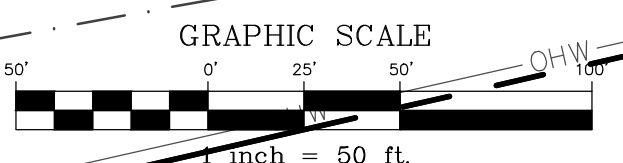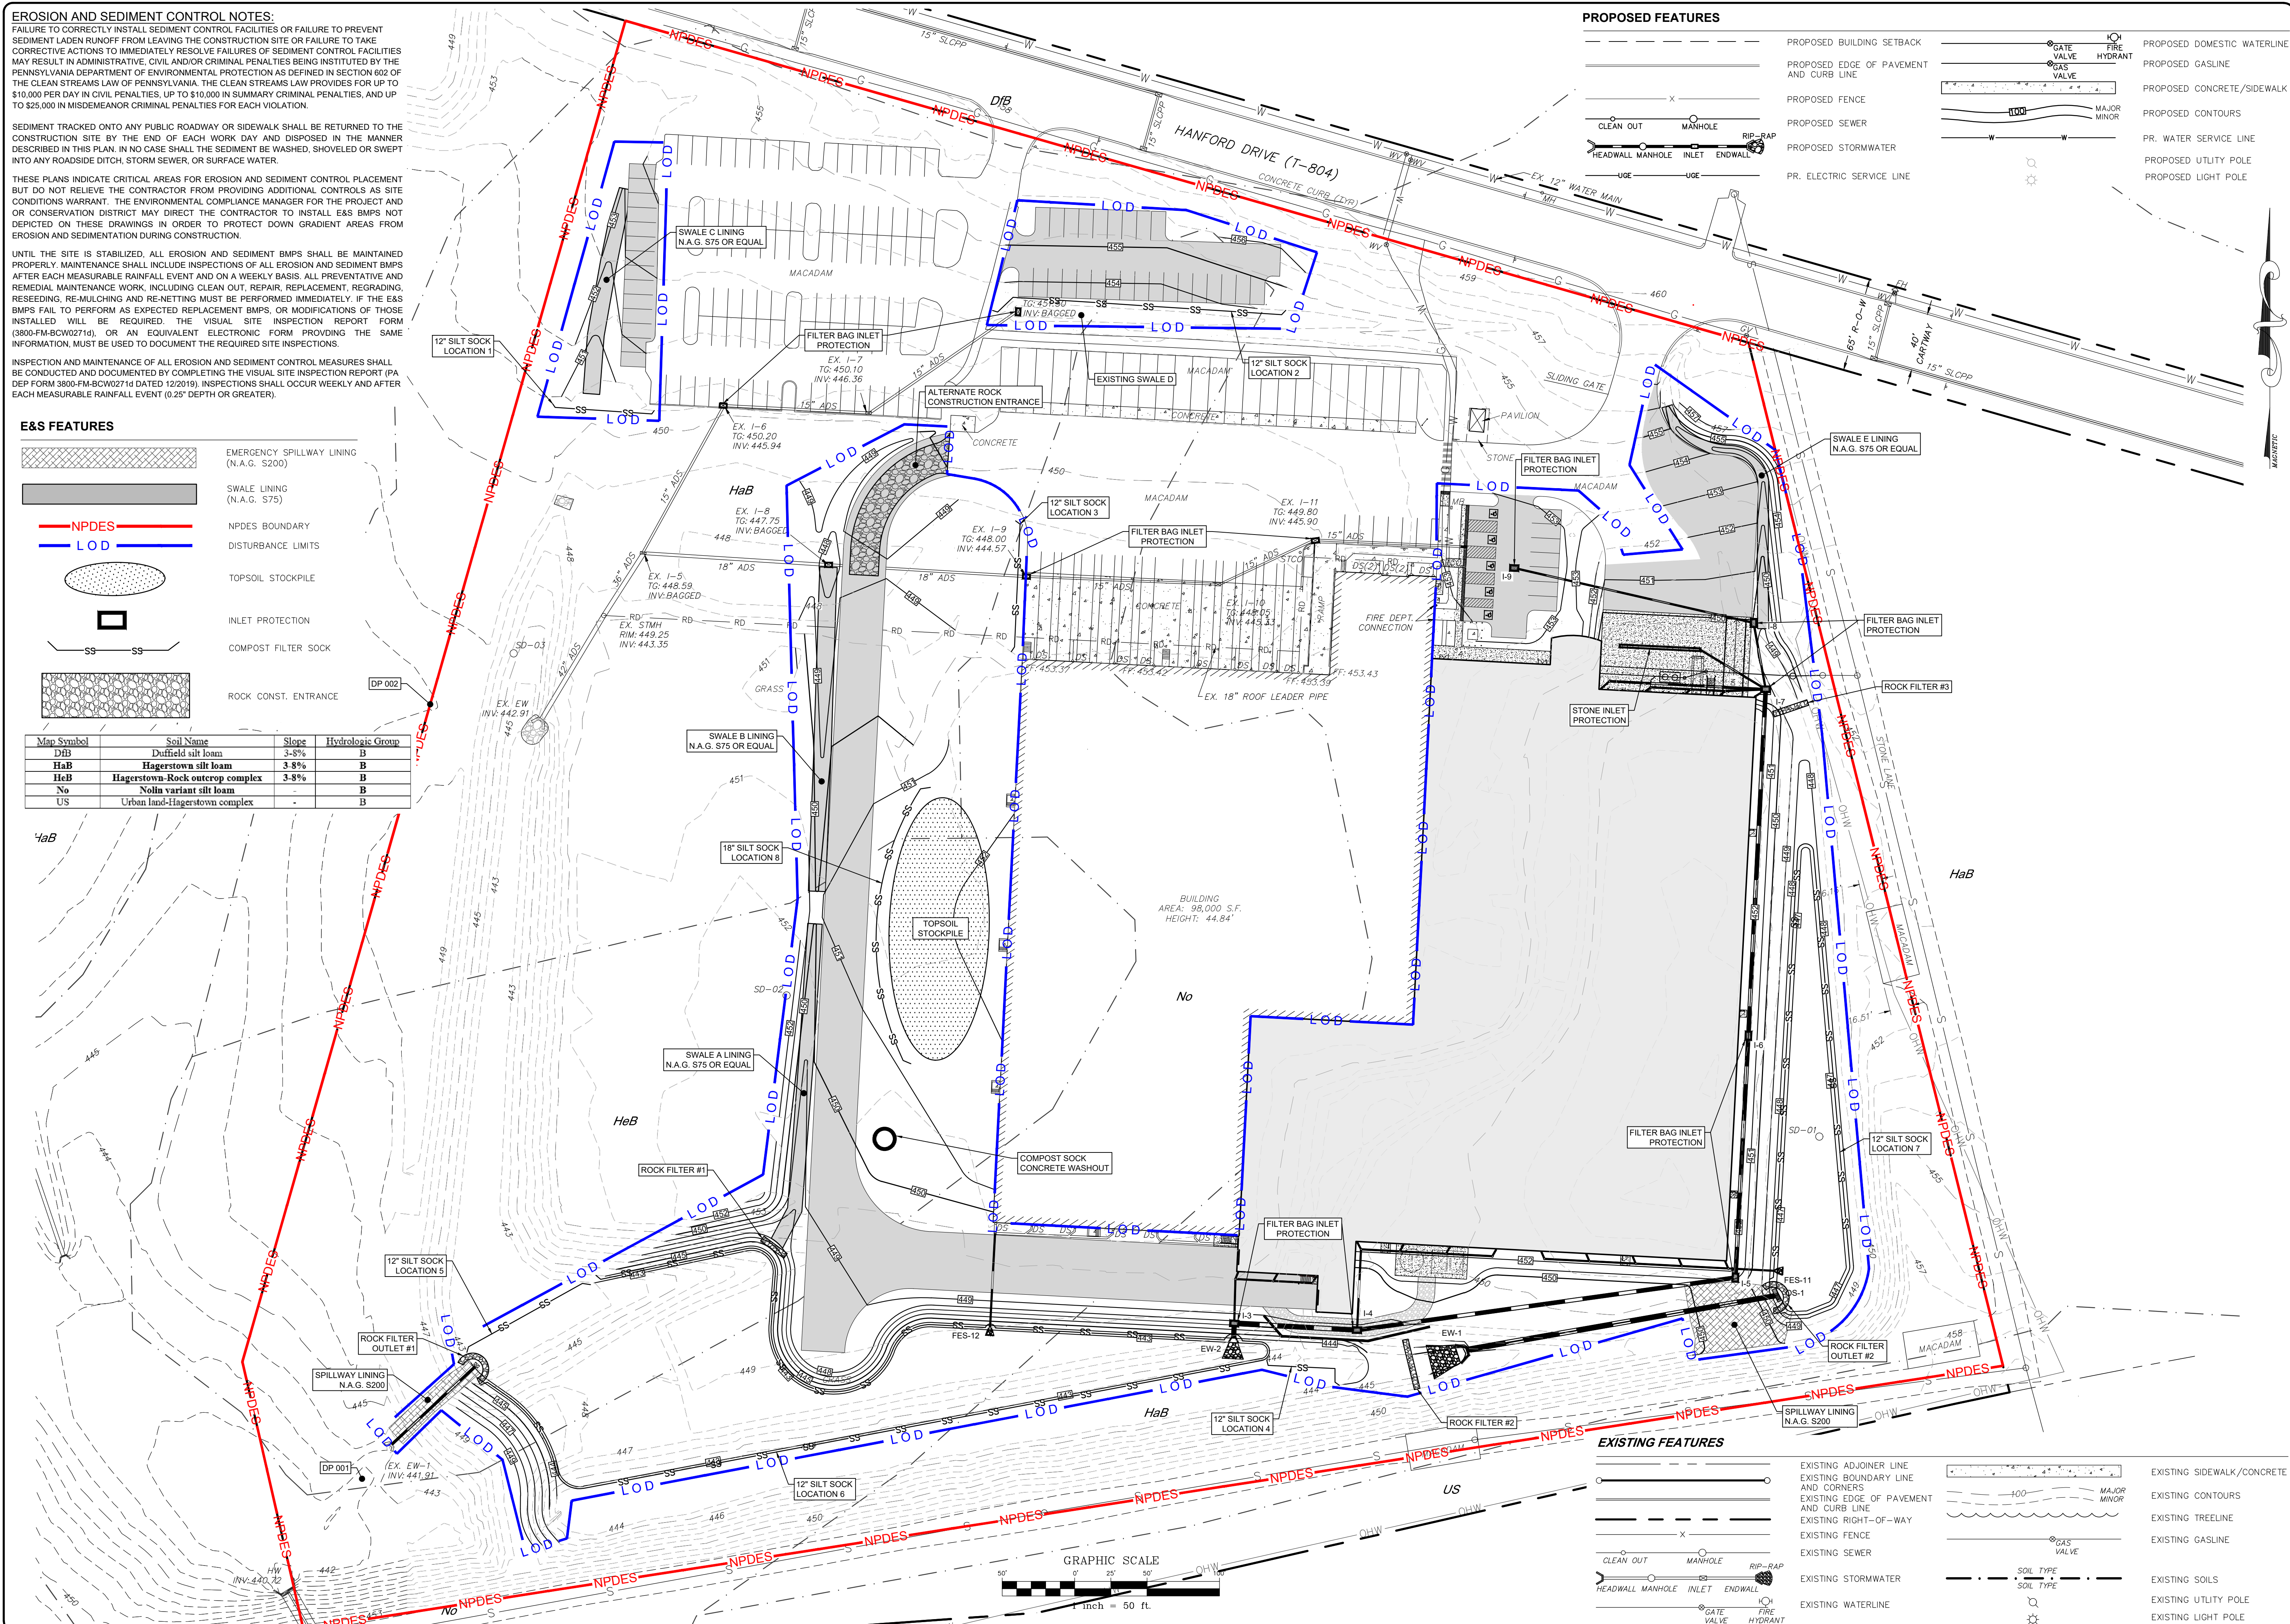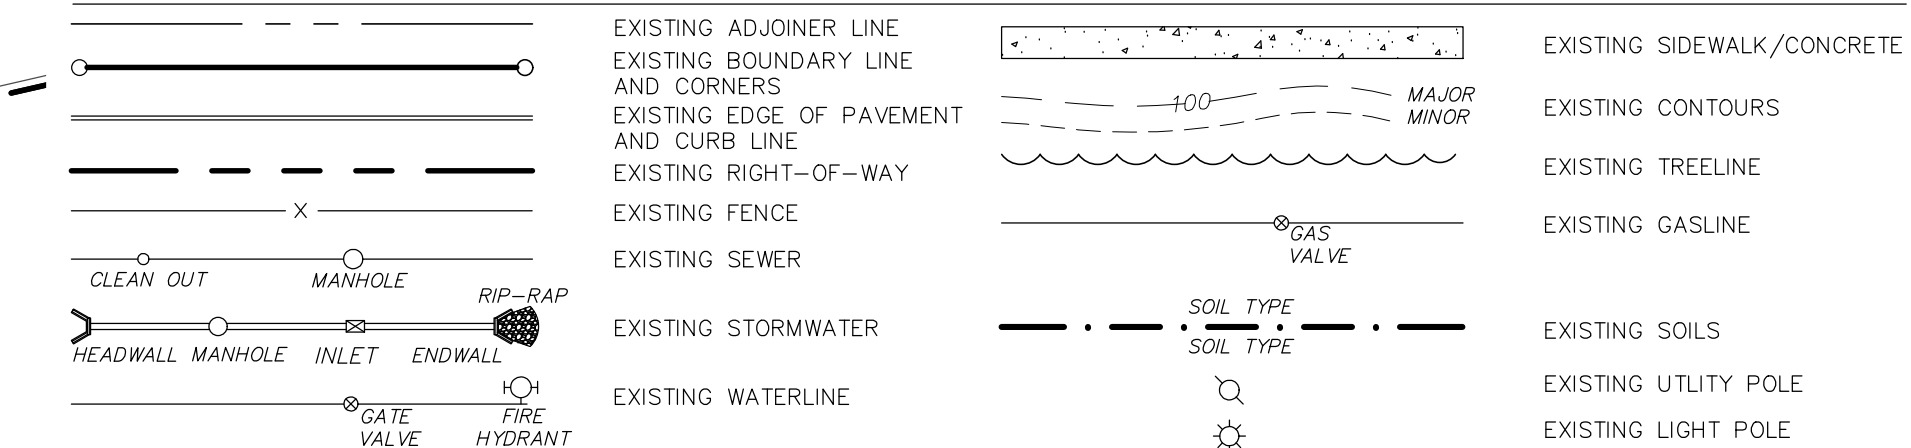

BY	DATE	REVISION


BY	DATE	REVISION

**EROSION & SEDIMENTATION POLLUTION CONTROL PLAN**  
**PRELIMINARY/FINAL LAND DEVELOPMENT PLANS**  
 For  
**SCOUT COLD LOGISTICS, LLC**  
 located in  
 NORTH LEBANON TOWNSHIP  
 LEBANON County, Pennsylvania

FIELD CREW: MOD,JEC
BASE MAP: JEC
DRAWN: CDS
DESIGN: CDS
CHECKED: SAS
DATE: 02/26/24
SCALE: 1" = 50'
PROJECT # 2368-23-001





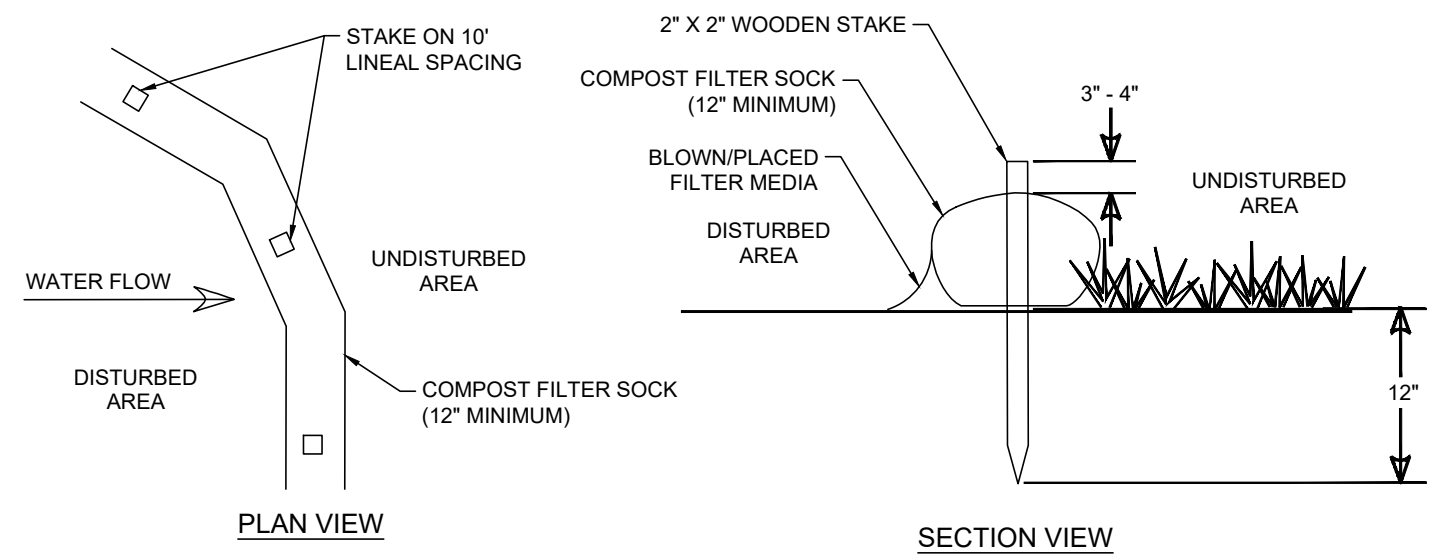


- INSTALLATION NOTES:**
1. ALL MATERIAL TO MEET FILLREXX SPECIFICATIONS.
  2. FILTER SOCK COMPOST/SOIL/ROCK/SEED FILL TO MEET APPLICATION REQUIREMENTS.
  3. FILTER SOCK DEPICTED IS FOR MINIMUM SLOPES. GREATER SLOPES MAY REQUIRE LARGER SOCKS PER THE ENGINEER.
  4. COMPOST MATERIAL TO BE DISPERSED ON SITE, AS DETERMINED BY THE ENGINEER.

- MAINTENANCE NOTES:**
1. THE CONTRACTOR SHALL MAINTAIN THE FILTER SOCK IN A FUNCTIONAL CONDITION AT ALL TIMES AND IT SHALL BE ROUTINELY INSPECTED.
  2. IF THE FILTER SOCK HAS BEEN DAMAGED, IT SHALL BE REPAIRED, OR REPLACED IF BEYOND REPAIR.
  3. THE CONTRACTOR SHALL REMOVE SEDIMENT AT THE BASE OF THE UPSLOPE SIDE OF THE FILTER SOCK WHEN ACCUMULATION HAS REACHED 1/2 OF THE EFFECTIVE HEIGHT OF THE FILTER SOCK, OR AS DIRECTED BY THE LOCAL COUNTY CONSERVATION DISTRICT. ALTERNATIVELY, A NEW FILTER SOCK CAN BE PLACED ON TOP OF AND SLIGHTLY BEHIND THE ORIGINAL ONE CREATING MORE SEDIMENT STORAGE CAPACITY WITHOUT SOIL DISTURBANCE.
  4. FILTER SOCK SHALL BE MAINTAINED UNTIL DISTURBED AREA ABOVE THE DEVICE HAS BEEN PERMANENTLY STABILIZED AND CONSTRUCTION ACTIVITY HAS CEASED.
  5. THE FILTER MEDIA WILL BE DISPERSED ON SITE ONCE DISTURBED AREA HAS BEEN PERMANENTLY STABILIZED, CONSTRUCTION ACTIVITY HAS CEASED, OR AS DETERMINED BY THE LOCAL COUNTY CONSERVATION DISTRICT.
  6. FOR LONG-TERM SEDIMENT AND POLLUTION CONTROL APPLICATION, FILTER SOCK CAN BE SEEDED AT THE TIME OF INSTALLATION TO CREATE A VEGETATIVE FILTERING SYSTEM FOR PROLONGED AND INCREASED FILTRATION OF SEDIMENT AND SOLUBLE POLLUTANTS (CONTAINED VEGETATIVE FILTER STRIP). THE APPROPRIATE SEED MIX SHALL BE DETERMINED BY THE DESIGN PROFESSIONAL.

**COMPOST FILTER SOCK DETAIL**

NO SCALE

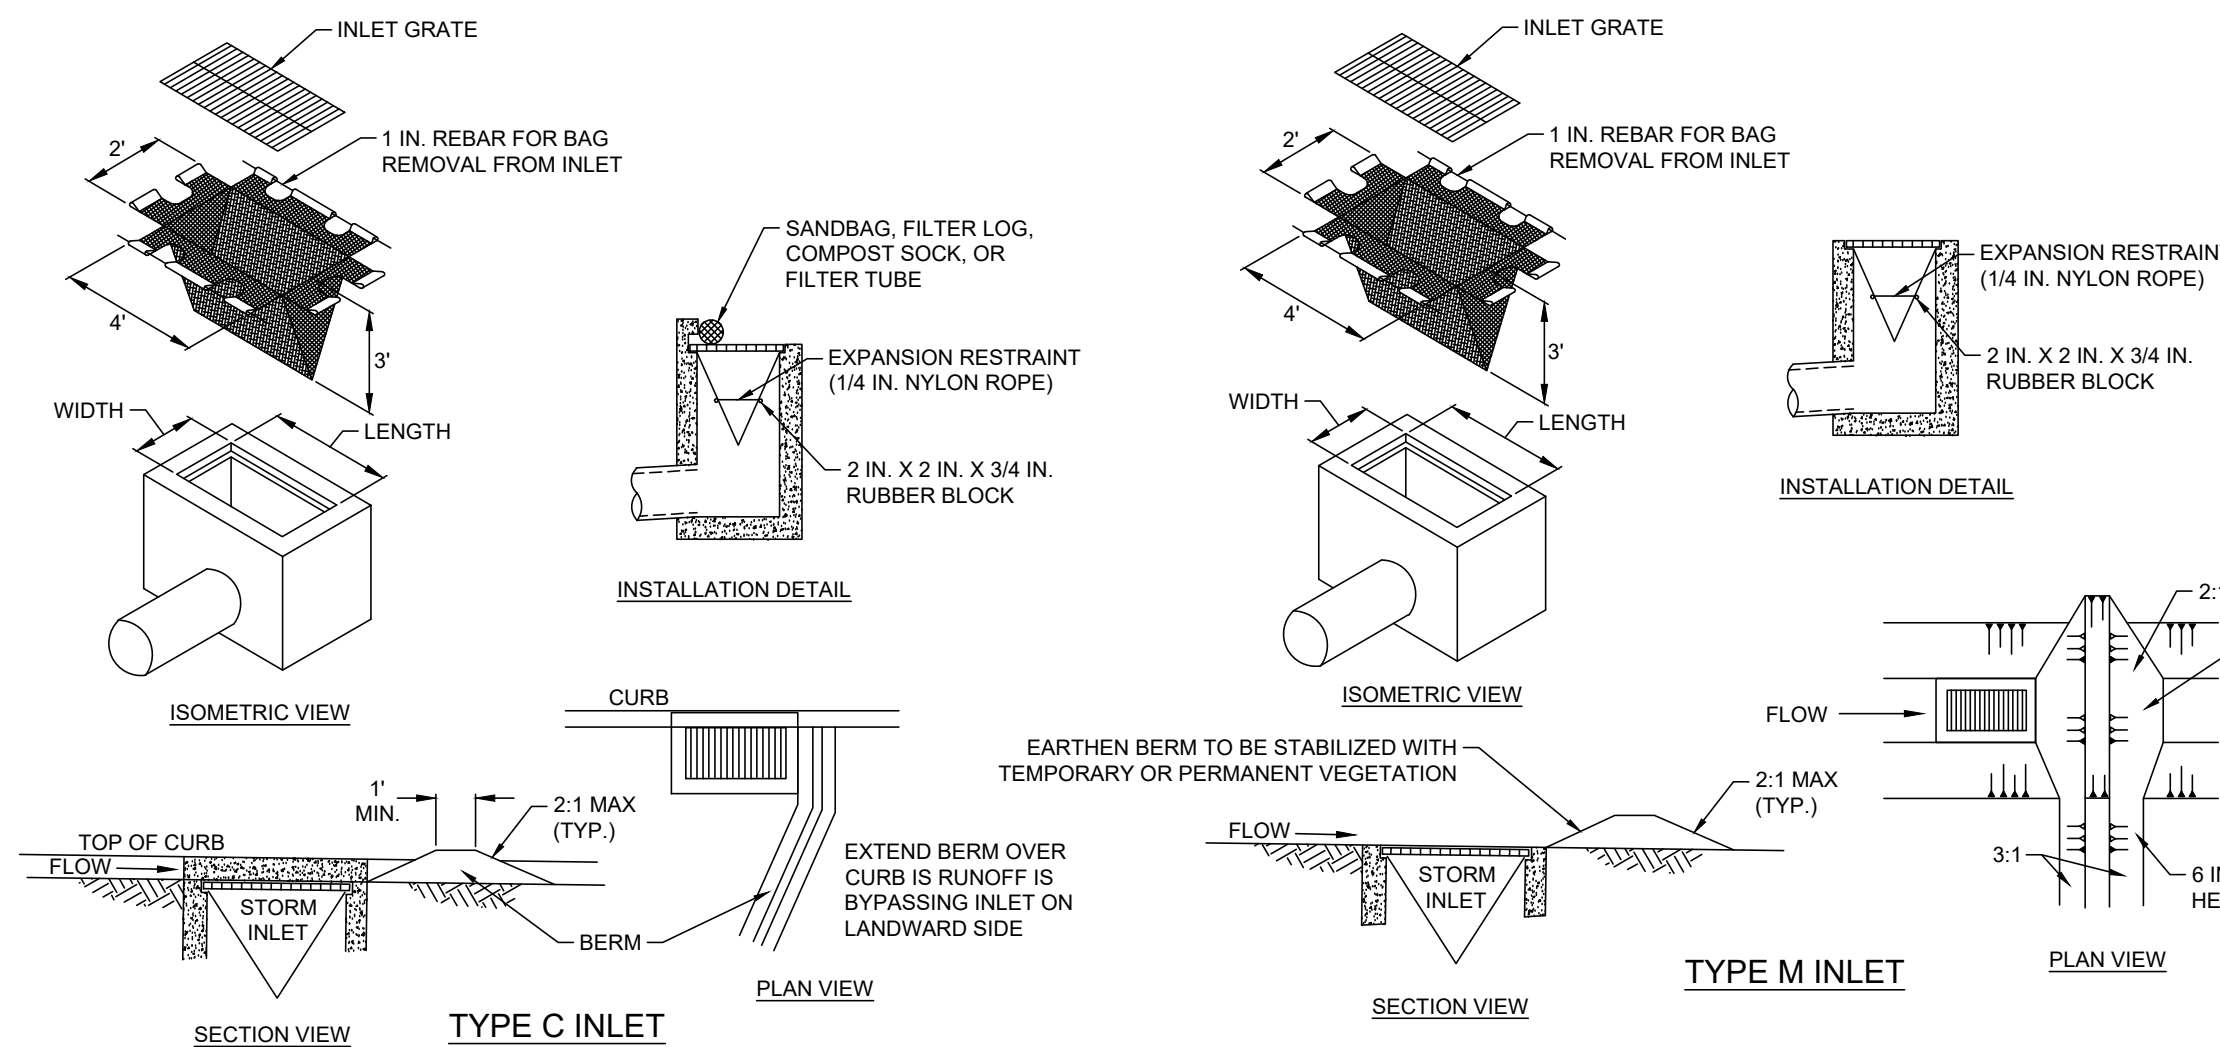


**FILTER BAG INLET PROTECTION DETAIL - TYPE M & C INLETS**

NO SCALE


**NOTES:**

1. MAXIMUM DRAINAGE AREA = 1/2 ACRE.
2. INLET PROTECTION SHALL NOT BE REQUIRED FOR INLET TRIBUTARY TO SEDIMENT BASIN OR TRAP. BERMS SHALL BE REQUIRED FOR ALL INSTALLATIONS.
3. ROLLED EARTHEN BERM SHALL BE MAINTAINED UNTIL ROADWAY IS STONED. ROAD SUBBASE BERM SHALL BE MAINTAINED UNTIL ROADWAY IS PAVED. SIX INCH MINIMUM HEIGHT ASPHALT BERM SHALL BE MAINTAINED UNTIL ROADWAY SURFACE RECEIVES FINAL COAT.
4. AT A MINIMUM, THE FABRIC SHALL HAVE A MINIMUM GRAB TENSILE STRENGTH OF 120 LBS. A MINIMUM BURST STRENGTH OF 200 PSI, AND A MINIMUM TRAPEZOIDAL TEAR STRENGTH OF 50 LBS. FILTER BAGS SHALL BE CAPABLE OF TRAPPING ALL PARTICLES NOT PASSING A NO. 40 SIEVE.
5. INLET FILTER BAGS SHALL BE INSPECTED ON A WEEKLY BASIS AND AFTER EACH RUNOFF EVENT. BAGS SHALL BE EMPTIED AND RINSED OR REPLACED WHEN HALF FULL OR WHEN FLOW CAPACITY HAS BEEN REDUCED SO AS TO CAUSE FLOODING OR BYPASSING OF THE INLET. DAMAGED OR CLOGGED BAGS SHALL BE REPLACED. A SUPPLY SHALL BE MAINTAINED ON SITE FOR REPLACEMENT OF BAGS. ALL NEEDED REPAIRS SHALL BE INITIATED IMMEDIATELY AFTER THE INSPECTION. DISPOSE OF ACCUMULATED SEDIMENT AS WELL AS ALL USED BAGS ACCORDING TO THE PLAN NOTES.
6. DO NOT USE ON MAJOR PAVED ROADWAYS WHERE PONDING MAY CAUSE TRAFFIC HAZARDS.

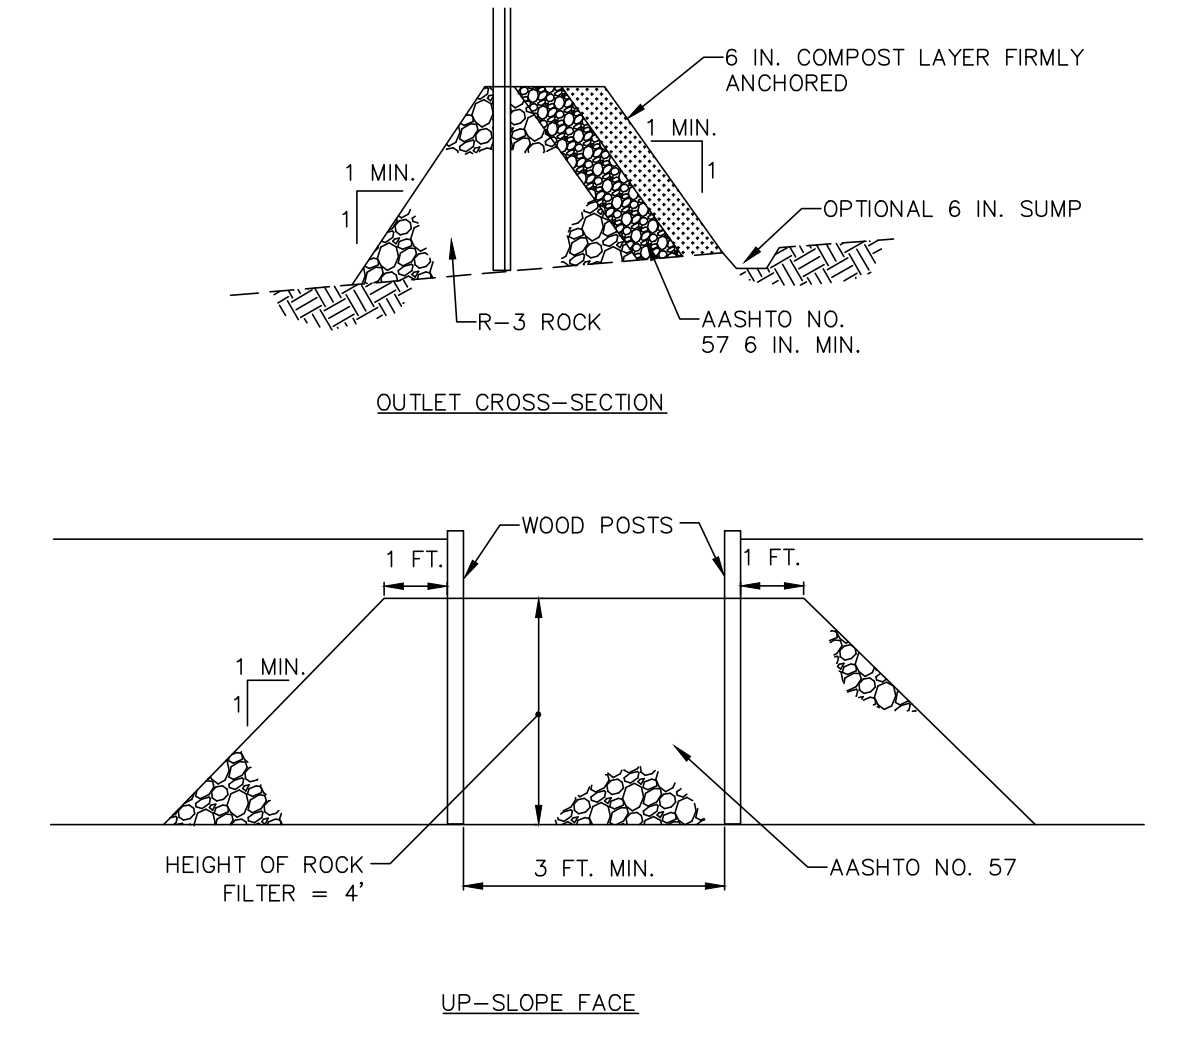

**ROCK FILTER OUTLET WITH COMPOST DETAIL**


NO SCALE

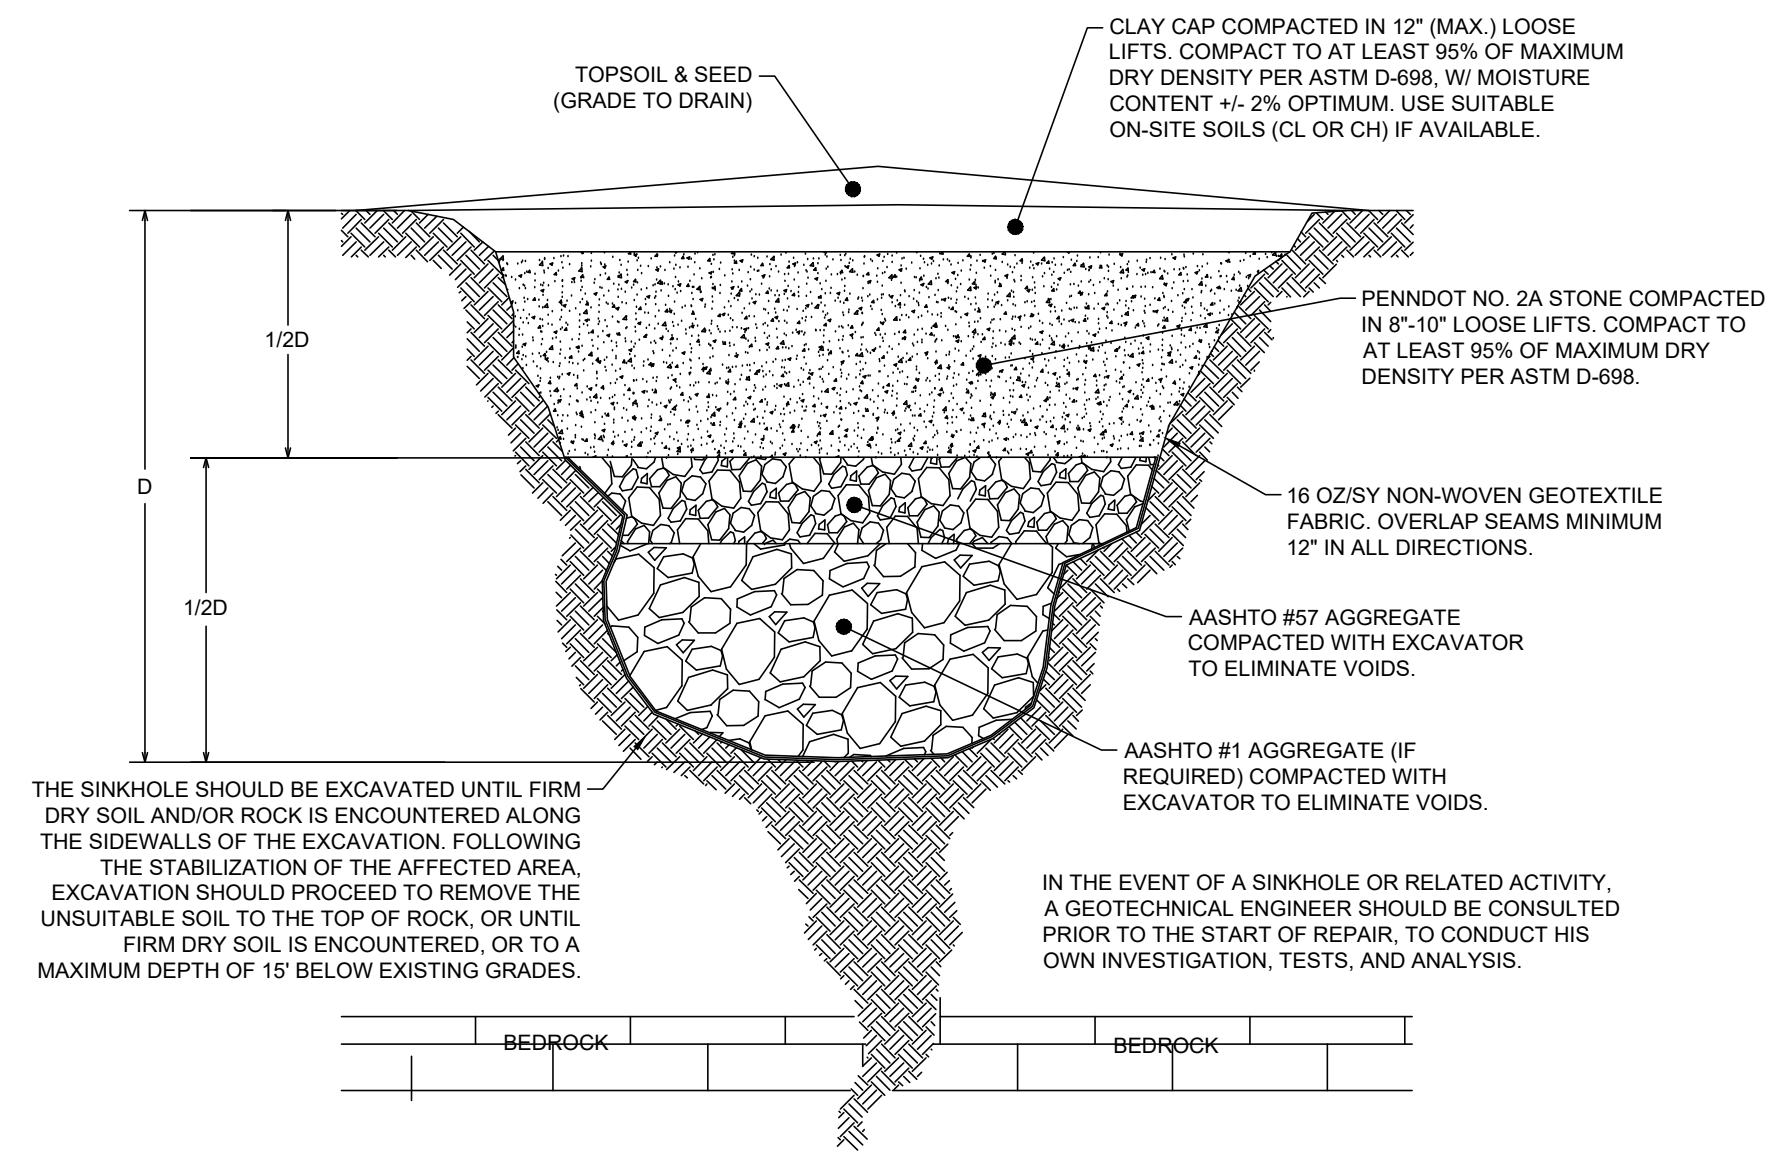

\*NOTE: ALL SINKHOLE MITIGATION MEASURES SHALL BE APPROVED BY A QUALIFIED GEOLOGIST OR GEOTECHNICAL ENGINEER PRIOR TO IMPLEMENTATION.

**SINKHOLE REPAIR DETAIL-BEDROCK THROAT NOT ENCOUNTERED**


NO SCALE

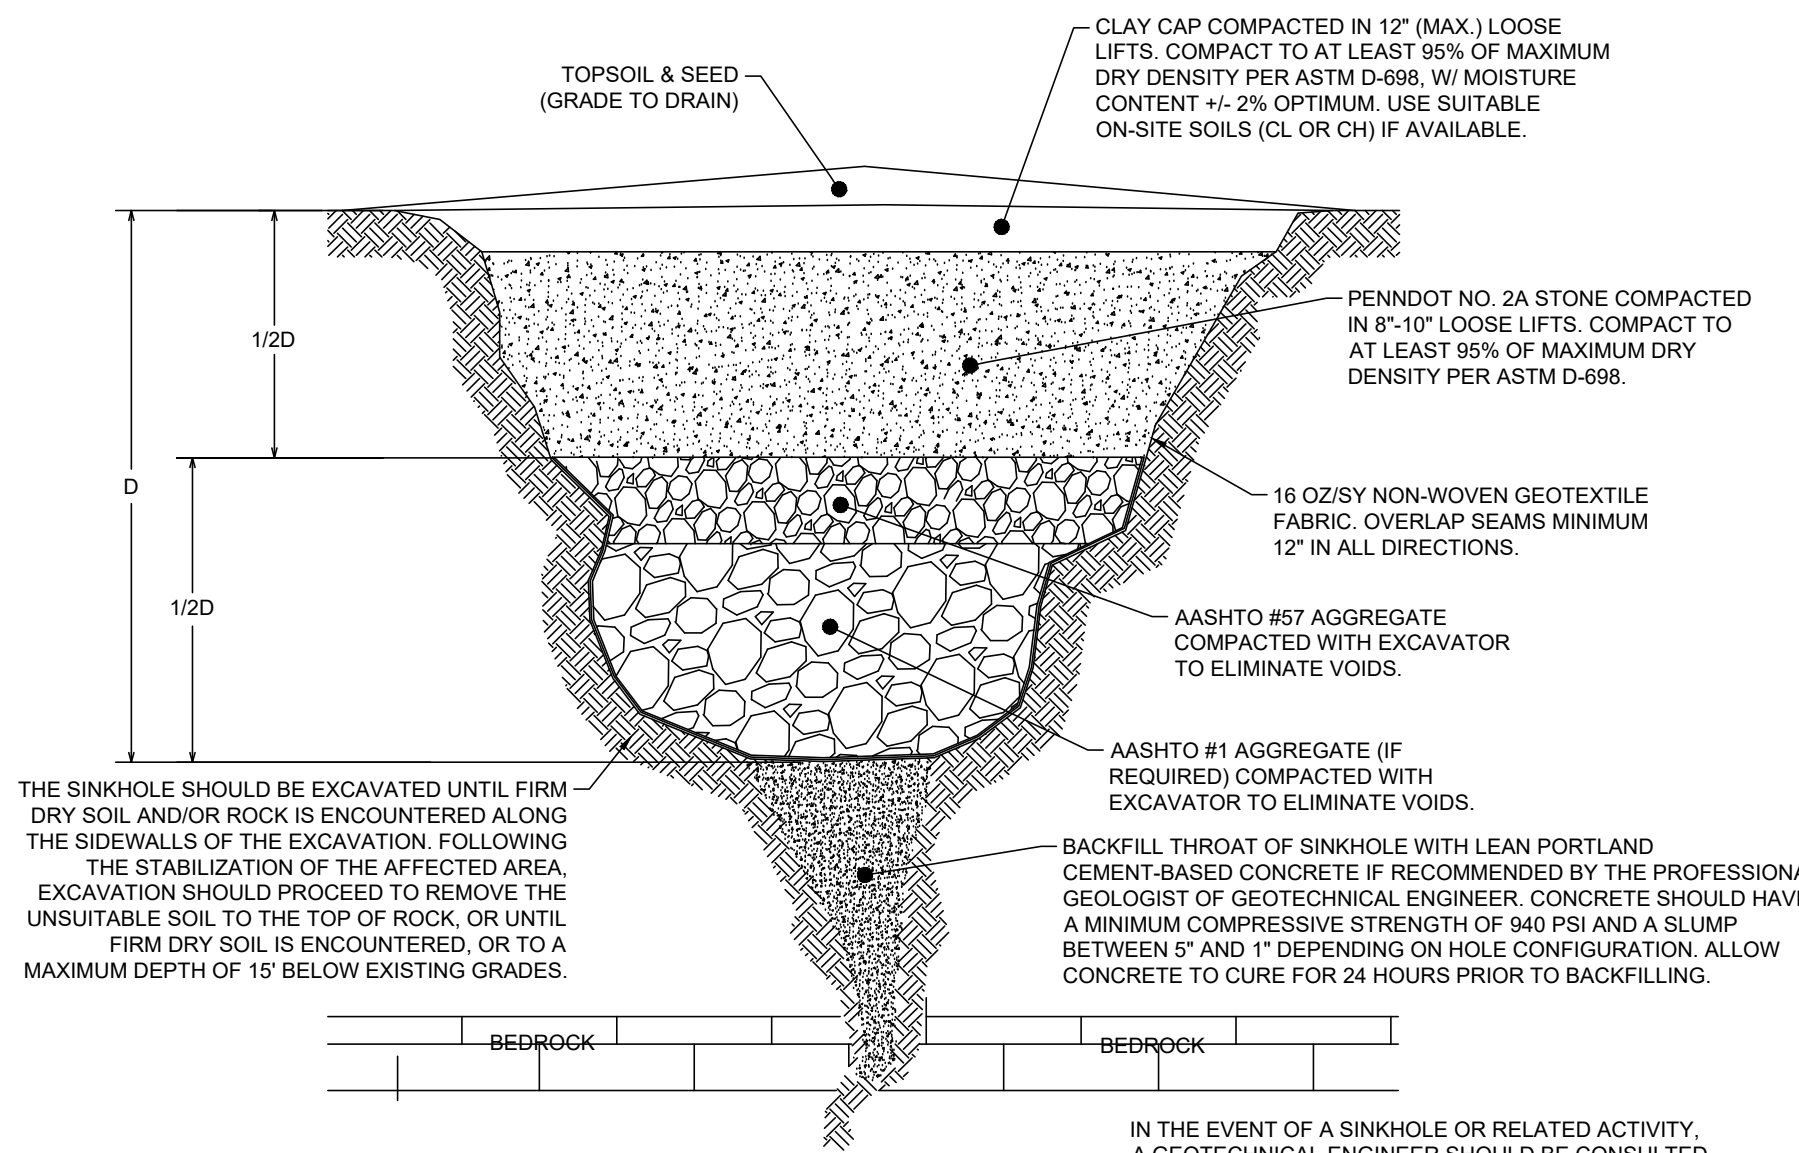

\*NOTE: ALL SINKHOLE MITIGATION MEASURES SHALL BE APPROVED BY A QUALIFIED GEOLOGIST OR GEOTECHNICAL ENGINEER PRIOR TO IMPLEMENTATION.

**SINKHOLE REPAIR DETAIL-BEDROCK THROAT ENCOUNTERED**


NO SCALE

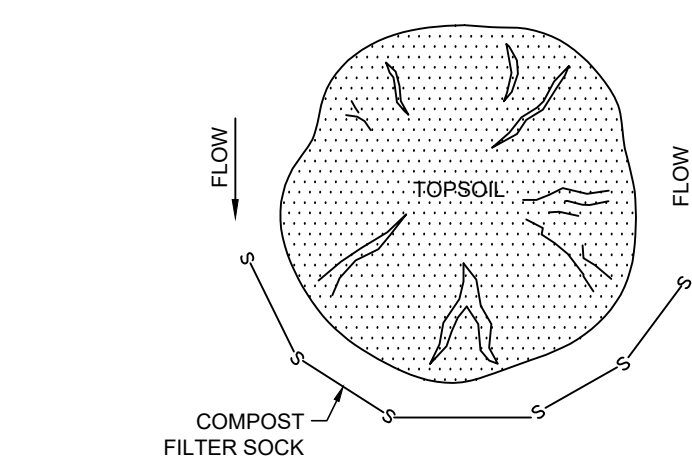

- NOTES:**
1. A STOCKPILE SHALL BE USED TO CONTAIN ALL STRIPPED TOPSOIL IN A LIMITED AREA IN ORDER TO KEEP DISTURBANCE TO A MINIMUM.
  2. STOCKPILES ARE TO BE STABILIZED IMMEDIATELY.
  3. STOCKPILE HEIGHTS MUST NOT EXCEED 35 FEET.
  4. STOCKPILE SLOPES MUST BE 2:1 OR FLATTER.
  5. STOCKPILES SHALL BE LOCATED SO THAT ALL SWALES CAN FUNCTION AS DESIGNED.

**TOPSOIL STOCKPILE**

NO SCALE

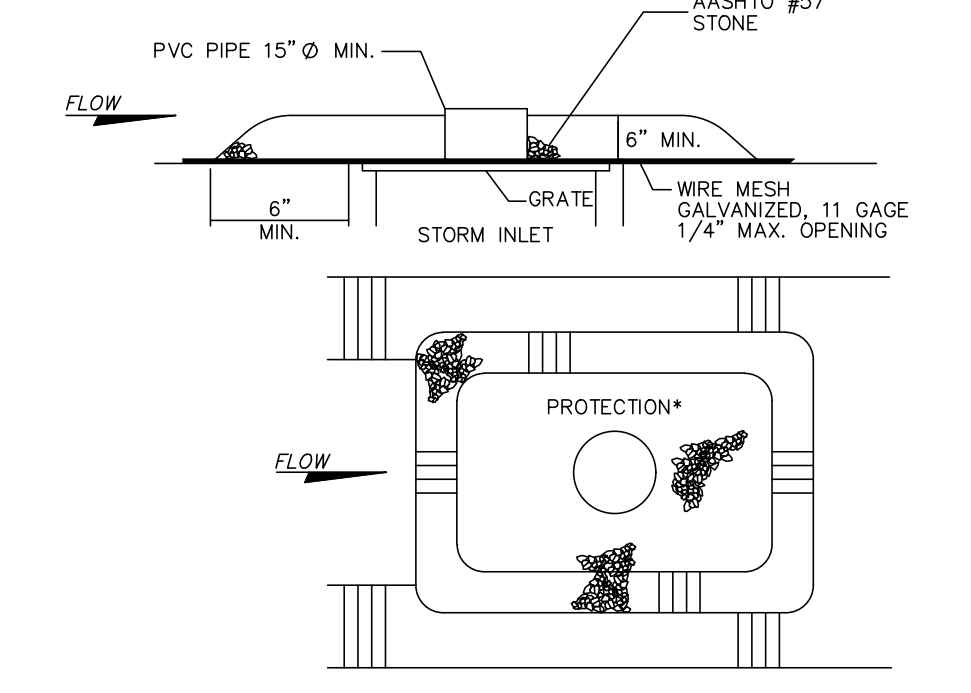

**STONE INLET PROTECTION DETAIL**

NO SCALE

**EROSION & SEDIMENTATION POLLUTION CONTROL DETAILS**  
**PRELIMINARY/FINAL LAND DEVELOPMENT PLANS**  
 For  
**SCOUT COLD LOGISTICS, LLC**  
 located in  
 NORTH LEBANON TOWNSHIP  
 LEBANON County, Pennsylvania

**esi**  
 Steadbeck Engineering & Surveying, Inc.  
 279 Lebanon, Pennsylvania 17042  
 Phone: (717) 272-7110  
 Fax: (717) 272-7348

FIELD CREW: MOD, JEC  
 BASE MAP: JEC  
 DRAWN: CDS  
 DESIGN: CDS  
 CHECKED: SAS  
 DATE: 02/26/24  
 SCALE: AS NOTED  
 PROJECT # 2368-23-001